CODE ANALYSIS APPLICABLE CODES National Electrical Code Building Conservation ADA Accessibility International Energy Conservation Code DEMOLITION ONLY EXISTING HEATING CENTRAL PLANT-DEMOLITION Change in Use: Yes X No Mixed Occupancy: Yes No X Special Use and Occupancy (e.g. High Rise, Covered Mall): CENTRAL PLANT Seismic Design Category: _____ Type of Construction (circle one): EXISTING HEATING CENTRAL PLANT D. Fire Resistance Rating Requirements for the Exterior Walls based on the fire separation distance (in hours): N/A Mixed Occupancies: N/A Nonseparated Uses: N/A Provided: _____ Type of Sprinkler System: H: Actual Area per Floor (square feet): N/A Tabular Area: N/A Area Modifications: N/A a) $A_a = A_t + \left[\frac{A_t I_f}{100}\right] + \left[\frac{A_t I_s}{100}\right]$ $I_f = 100 \left[\frac{F}{P} - 0.25\right] \frac{W}{30}$ b) Sum of the Ratio Calculations for Mixed Occupancies: c) Total Allowable Area for: 1) One Story: _____ 2) Two Story: A_a(2)_____ 3) Three Story: A_a(3)___ d) Unlimited Area Building: Yes _____ No ____ Code Section: ____ K. Fire Resistance Rating Requirements for Building Elements (hours). N/A Floors - Ceiling Floors **Exterior Bearing Walls** Interior Bearing Walls Roofs - Ceiling Roofs **Exterior Non-Bearing Walls Exterior Doors and Windows** Fire Walls Partitions - Permanent Fire Barriers Fire Partitions **Smoke Partitions** Design Occupant Load: N/A Exit Width Required: _____ Exit Width Provided: _____ M. Minimum Number of Required Plumbing Facilities: N/A b) Lavatories - Required (m) _____ (f) ____ Provided (m) ____ c) Bath Tubs or Showers: _____ d) Drinking Fountains: _____ Service Sinks: ____ FOOTNOTES: 1) In case of conflict with the U.S. Department of Justice Federal Registers Parts I through **▼** - ADA Guidelines and specific reference to the International Building Code Accessibility Chapters, the more restrictive requirement shall govern. 2) Additional Code Information shall be provided at the discretion of the Building Official for Complex Buildings. Including, but not limited to: a) High Rise Requirements.

c) Performance Based Criteria. d) Means or Egress Analysis. e) Fire Assembly Locator Sheet.

f) Exterior and Interior Accessibility Route.

g) Fire Stopping, Including Tested Design Number.

WEBER STATE UNIVERSITY HEATING PLANT - BOILER REPLACEMENT DEMOLITION PHASE

DFCM PROJECT NO. 07049810 OGDEN CITY, UTAH



State of Utah—Department of Administrative Services

DIVISION OF FACILITIES CONSTRUCTION AND MANAGEMENT

4110 State Office Building / Salt Lake City, Utah 84114 / 538-3018

DRAWING INDEX:

- G001 COVER SHEET
- M001 MECHANICAL GENERAL NOTES & LEGEND MD101 - LOWER LEVEL BOILER ROOM MECHANICAL AND PIPING DEMOLITION PLAN
- - MD103 BOILER #1 DEMOLITION PHOTOGRAPHS
 - MD104 BOILER #2 DEMOLITION PHOTOGRAPHS
 - MD105 BOILER #1 & #2 DEMOLITION PHOTOGRAPHS MD106 - ROOF & CATWALK DEMOLITION PHOTOGRAPHS
- Weber State University

MECHANICAL ENGINEER WHW ENGINEERING, INC. 1354 EAST 3300 SOUTH SUITE 200 SALT LAKE CITY, UTAH 84106 PHONE: (801) 466-4021 FAX: (801) 466-8536



WHW ENGINEERING INC. PROFESSIONAL MECHANICAL ENGINEERING SALT LAKE CITY, UTAH 84106 (801)466-4021, FAX 466-8536



MECHANICAL LEGEND									
SYMBOL	ABR.	DESCRIPTION	SYMBOL	ABR.	DESCRIPTION	SYMBOL	ABR.	DESCRIPTION	
GENERAL TERMINOLOGY					WET SIDE	WET SIDE CONT			
A		SECTION LETTER DESIGNATION			UNION			PITCH DOWN	
ME-101		-SECTION DRAWN ON THIS SHEET	Г		MANUAL ACTUATOR (BALL,	0		ELBOW UP	
(12)		- DETAIL NUMBER DESIGNATION			BUTTERFLY, NEEDLE, ETC. VALVES)	G		ELBOW DOWN	
(A2)		CORRESPONDING WITH GRID LOCATION		MANUAL ACTUATOR (GATE, GLOBE,			TEE UP		
AH		MECHANICAL EQUIPMENT DESIGNATION			S&D, OS&Y, ETC. VALVES)			TEE DOWN	
1		- EQUIPMENT ITEM DESIGNATION	\rightarrow		THREADED OR SWEAT VALVE CONNECTION			EXISTING PIPING TO BE REMOVED	
L-1		GRILLE, OR LOUVER DESIGNATION WHERE			FLANGED VALVE CONNECTION			EXISTING PIPING TO REMAIN	
		BALANCING NOT REQUIRE	<u> </u>		BUTTERFLY VALVE			NEW PIPING	
À		REVISION DESIGNATOR AND NUMBER	→ ▼—		GATE VALVE			PIPE CAP OR PLUG	
(1)		KEY NOTE DESIGNATOR AND NUMBER	_\ <u>\</u>		CHECK VALVE			CONCENTRIC REDUCER	
•	POC	POINT OF CONNECTION	────	PRV	PRESSURE REDUCING VALVE			ECCENTRIC REDUCER	
$\overline{\bullet}$	POR	POINT OF REMOVAL	— ¥—	CBV	CIRCUIT BALANCING VALVE			EXPANSION JOINT	
AFF		ABOVE FINISHED FLOOR	— Ф—	BV	BALL VALVE	—-G-		NATURAL GAS PIPING	
۹ EL.		CENTER LINE ELEVATION		PRV	PRESSURE RELIEF VALVE		CW	CULINARY COLD WATER	
GC		GENERAL CONTRACTOR	_		AUTOMATIC AIR VENT	— D —		EQUIPMENT DRAIN	
MC		MECHANICAL CONTRACTOR	_ * _		MANUAL AIR VENT	—HPS —		HIGH PRESSURE STEAM	
EC		ELECTRICAL CONTRACTOR	_2		STRAINER	—HPR —		HIGH PRESSURE RETURN	
NIC		NOT IN CONTRACT	7		STRAINER W/ PLUGGED BLOW OFF	—вғw —		BOILER FEEDWATER	
NTS		NOT TO SCALE		VTI	VENTURI	-ros -		FUEL OIL SUPPLY	
SYMBOL	BOL ABR. DESCRIPTION				PRESSURE GAUGE AND GAUGE COCK -	−FOR −		FUEL OIL RETURN	
		EXISTING EQUIPMENT TO BE REMOVED	PRESSURE GAUGE AND G		WATER				
		EXISTING EQUIPMENT TO REMAIN	Пинин		THEDMONETED AND THEDMONAGE				
		NEW EQUIPMENT			THERMOMETER AND THERMOWELL				
	•		<u> </u>	TW	THERMOWELL				
		-		DIRECTION OF FLOW					

GENERAL NOTES:

MECHANICAL INFORMATION FOR DEMOLITION IS NOT LIMITED TO THE MECHANICAL DRAWINGS. CONTRACTOR SHALL BE RESPONSIBLE FOR EXISTING CONDITIONS AND ANY OBSTRUCTIONS THAT COULD EFFECT THE DEMOLITIOIN SCOPE.

> A - THE DEMOLITION CONTRACTOR SHALL BE HELD RESPONSIBLE FOR THE REMOVAL OF ALL ITEMS ACCORDING TO THE TRUE INTENT AND MEANING OF THE DOCUMENTS.

> B - ANYTHING NOT CLEAR OR IN CONFLICT SHALL BE BROUGHT TO THE ATTENTION OF THE ENGINEER IN WRITING.

G-2 CONTRACTOR SHALL FIELD VERIFY ALL DIMENSIONS AND LOCATIONS. IF NECESSARY FOR DEMOLITION.

G-3 CONTRACTOR SHALL COORDINATE WITH WSU BEFORE DEMOLITION TO DETERMINE IF ANY REMOVED MATERIALS, EQUIPMENT ETC. SHALL REMAIN AS PROPERTY OF WSU. ALL OTHER MATERIALS, EQUIPMENT ETC. SHALL BE REMOVED FROM SITE AND DISPOSED OF IN AN APPROVED MANNER IN AN APPROVED DUMP SITE. ALL HAZARDOUS MATERIALS SHALL BE REMOVED AND DISPOSED PER CODE AND STANDARDS FOR HAZARDOUS MATERIALS.

State of Utah
Department of Administrative Services



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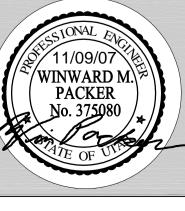
PROJECT NAME & ADDRESS

WEBER STATE UNIVERSITY HEATING **PLANT - BOILER REPLACEMENT**

DFCM No. 07049810


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	MANAGE				

11/9/07
WHW JOB NO.:
07037
SHEET TITLE



MECHANICAL GENERAL NOTES AND LEGEND

M001

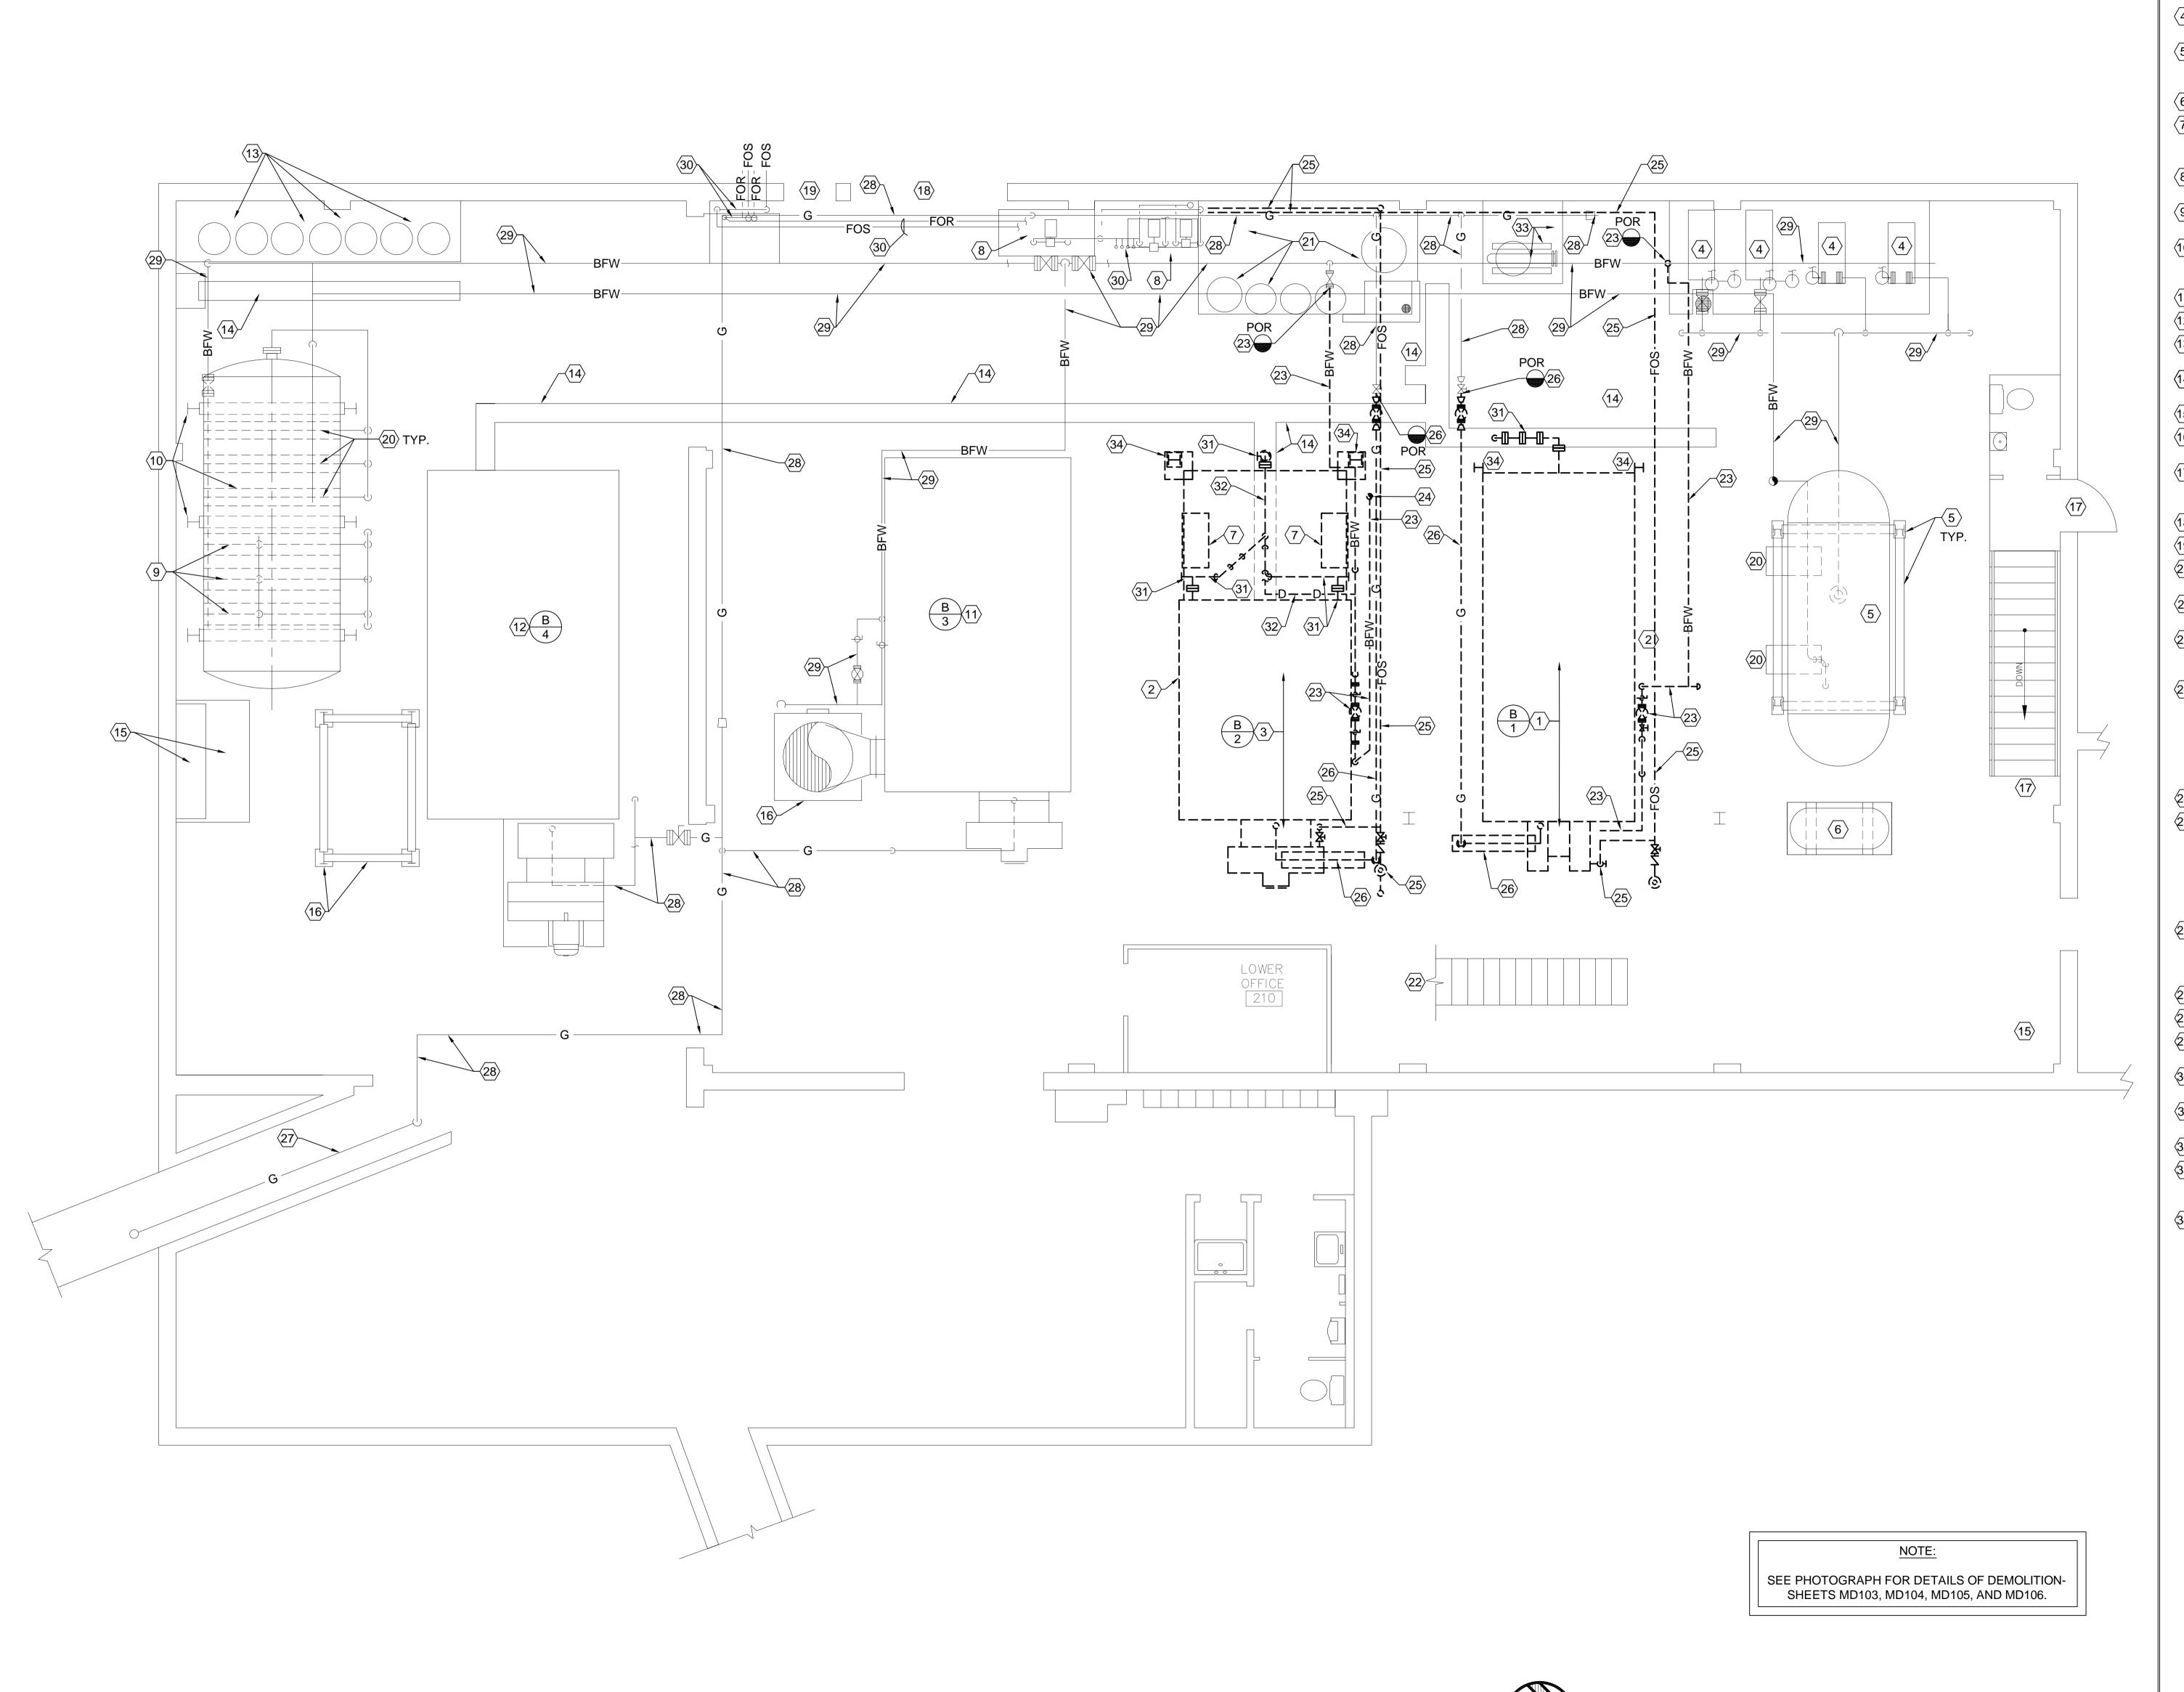

(1) REMOVE EXISTING BOILER #1 AND BURNER, ALL PIPING, CONTROLS, ELECTRICAL, SUPPORTS, STACK, FANS, DUCTWORK ETC. ASSOCIATED WITH BOILER #1.

(2) REMOVE EXISTING CONCRETE BOILER PAD

TO GROUND. (3) REMOVE EXISTING BOILER #2 AND BURNER, ALL PIPING, CONTROLS, ELECTRICAL,

SUPPORTS, STACK, FANS, DUCTWORK ETC. ASSOCIATED WITH BOILER #2. (4) EXISTING BOILER FEED WATER PUMPS FOR

SYSTEM #1 SHALL REMAIN. (5) EXISTING CONDENSATE TANK, DEAERATOR, STEEL SUPPORTS, PUMPS, PIPING ETC. FOR

SYSTEM #1 SHALL REMAIN. (6) EXISTING AIR COMPRESSOR SHALL REMAIN.

(7) REMOVE EXISTING CONCRETE PILLAR SUPPORTS UNDER BOILER #2. PILLARS ARE 3'-8" ABOVE FLOOR.

(8) EXISTING OIL PUMPS AND FOUNDATIONS SHALL REMAIN.

(9) EXISTING BOILER FEED WATER PUMPS FOR SYSTEM #2 SHALL REMAIN.

(10) EXISTING CONDENSATE TANK, DEAERATOR, STEEL SUPPORTS, PUMPS, PIPING ETC. FOR SYSTEM #2 SHALL REMAIN.

(11) EXISTING BOILER #3 SHALL REMAIN.

(12) EXISTING BOILER #4 SHALL REMAIN.

(13) EXISTING CHEMICAL TANKS AND PAD SHALL REMAIN.

(14) EXISTING COVERED TRENCH DRAIN SHALL REMAIN.

(15) ELECTRICAL AND PAD SHALL REMAIN.

(16) EXISTING ECONOMIZER AND STRUCTURAL SUPPORTS SHALL REMAIN.

(17) STAIRS FROM BOILER ROOM FLOOR TO UPPER LEVEL RESTROOM, EXIT DOOR TO GRADE AND ACCESS DOOR TO ROOF.

 $\langle 18 \rangle$ 9'-0" WIDE ROLL-UP DOOR.

 $\langle 19 \rangle$ 3'-0" MAN DOOR.

20 CONDENSATE PUMPS FOR SYSTEMS #1 AND #2 SHALL REMAIN.

(21) EXISTING SOFTENER SYSTEM, TANKS PIPING ETC. SHALL REMAIN.

22 STAIRS FROM BOILER ROOM FLOOR TO UPPER LEVEL. SEE SHEET MD102 FOR CONTINUATION.

23 REMOVE EXISTING BOILER FEED WATER PIPING FROM BOILER CONNECTION TO POINT SHOWN. REMOVE SUPPORTS, HANGER, VALVES, CONTROL VALVES, UNIONS, INSULATION, CONTROL AIR PIPING ETC. VALVE SHALL REMAIN. INSTALL BLIND FLANGE.

24 SEE SHEET MD102 FOR CONTINUATION.

25 REMOVE EXISTING FUEL OIL SUPPLY (TOP) AND RETURN (UNDER SUPPLY) FROM BURNER CONNECTION BACK TO HEADER VALVES. CAP VALVES AT HEADERS. REMOVE ALL OTHER VALVES, UNIONS, RELIEF VALVES, BACK PRESSURE VALVES, HANGERS, SUPPORTS ETC.

26 REMOVE EXISTING GAS PIPING, GAS TRAIN, PRV VALVE, HANGERS, SUPPORTS ETC. TO PLUG VALVE. PLUG VALVE SHALL REMAIN AND BE CAPPED.

27 EXISTING GAS PIPING IN TUNNEL.

(28) EXISTING GAS PIPING SHALL REMAIN.

29 EXISTING BOILER FEEDWATER PIPING SHALL

(30) EXISTING FOS AND FOR PIPING SHALL

(31) REMOVE EXISTING BLOWDOWN VALVES AND

PIPING AND CAP IN DRAIN TRENCH. (32) REMOVE EXISTING DRAIN PIPING.

(33) EXISTING CONDENSATE COOLER TANK, EXCHANGER, PIPING, SUPPORTS, PAD ETC.

SHALL REMAIN. (34) COLUMNS SHALL BE REMOVED ONLY AFTER CATWALKS ARE NO LONGER REQUIRED FOR DEMOLITION.

State of Utah Department of Administrative Services



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PROJECT NAME & ADDRESS

WEBER STATE UNIVERSITY HEATING **PLANT - BOILER** REPLACEMENT

DFCM No. 07049810

Ogden, Utah


MARK DATE REVISION

CHECKED BY:
SLW/WP 11/9/07 WHW JOB NO.: 07037

LOWER LEVEL BOILER ROOM MECHANICAL AND PIPING DEMOLITION PLAN

MD101

LOWER LEVEL BOILER ROOM MECHANICAL AND PIPING DEMOLITION PLAN

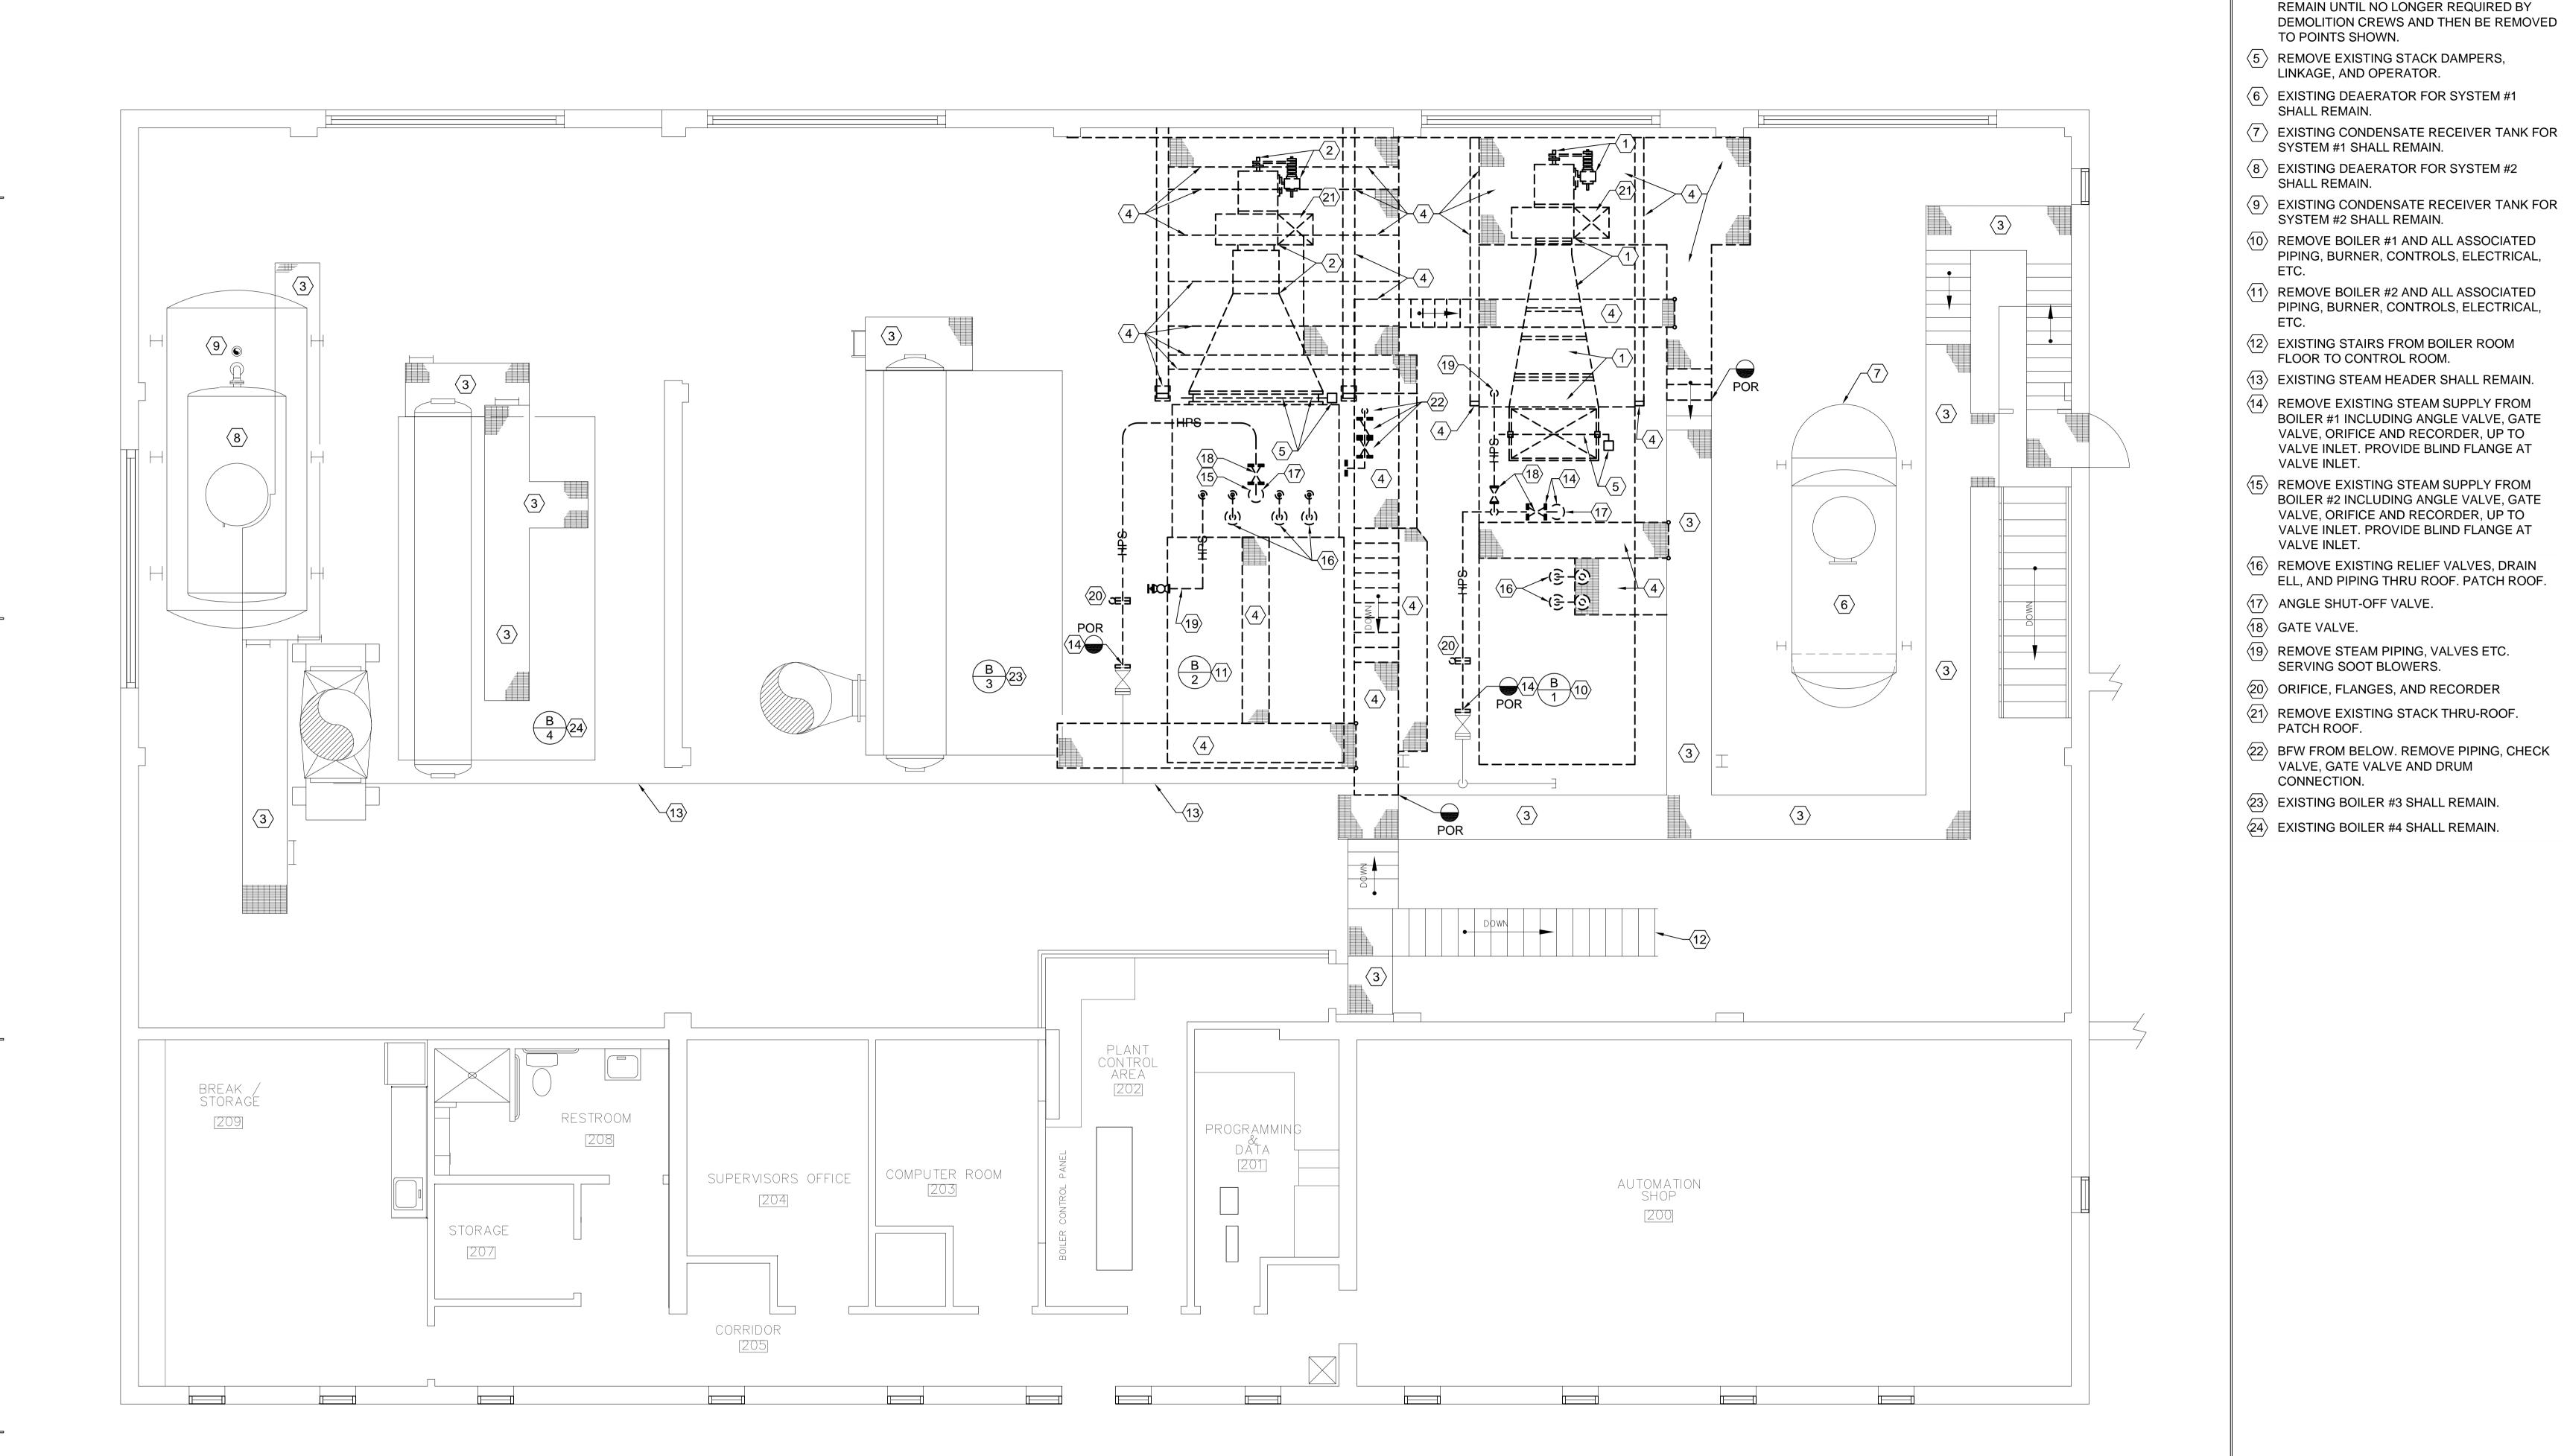

NOTE:

SEE PHOTOGRAPH FOR DETAILS OF DEMOLITIONSHEETS MD103, MD104, MD105, AND MD106.

UPPER LEVEL BOILER ROOM MECHANICAL DEMOLITION PLAN

SCALE: 1/4" = 1'-0"

SHEET NOTES

REMOVE EXISTING B-1 FAN, DUCT, AND STACK THRU ROOF. SEE PHOTO DETAIL A1

AND D3 SHEET MD106.

SHALL REMAIN.

STACK THRU ROOF. SEE PHOTO DETAIL A1 AND B1 SHEET MD106.


(2) REMOVE EXISTING B-2 FAN, DUCT, AND

 $\overline{\langle 3 \rangle}$ EXISTING CATWALK, HANDRAILS, AND STAIRS

STAIRS, LADDERS, AND HANDRAILS SHALL

(4) EXISTING CATWALK, STEEL SUPPORTS,



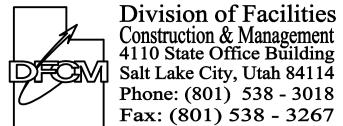

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DFCM No. 07049810

REVISION

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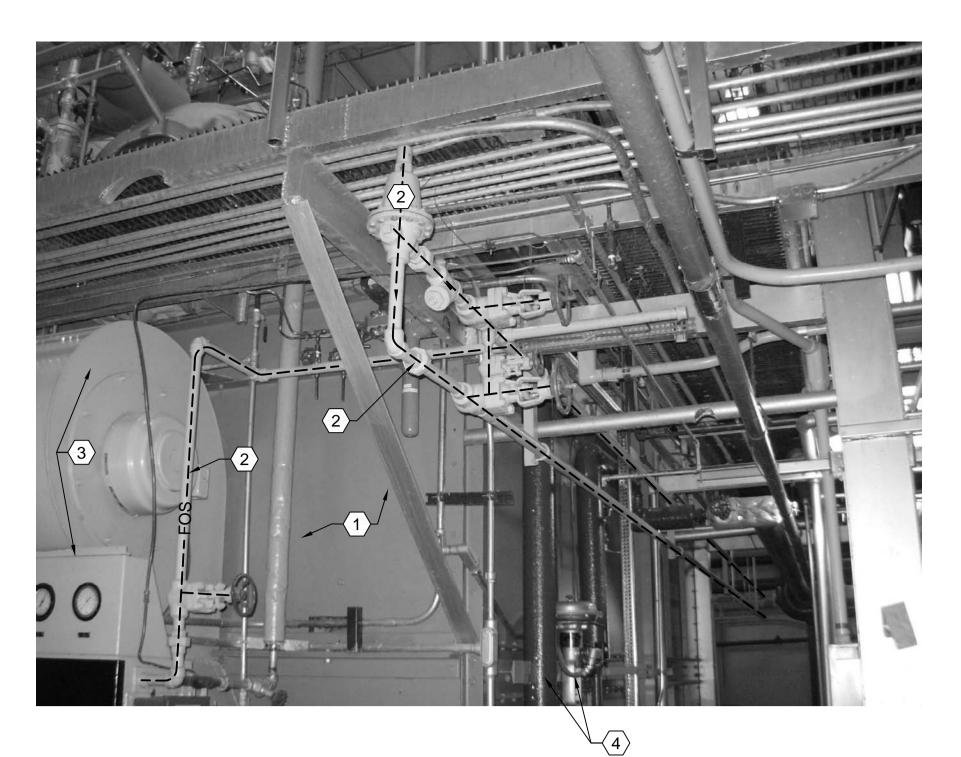
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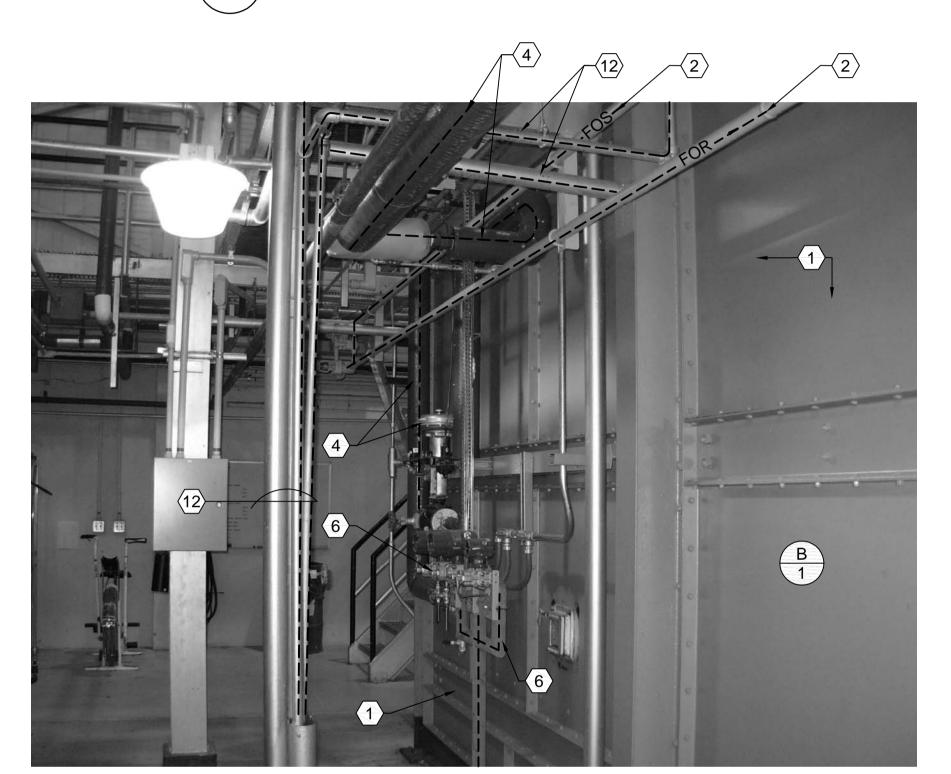
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UPPER LEVEL BOILER ROOM


MECHANICAL DEMOLITION
PLAN




BOILER #1 LOOKING SOUTHWEST




BOILER #1 LOOKING SOUTHEAST
SCALE: NONE

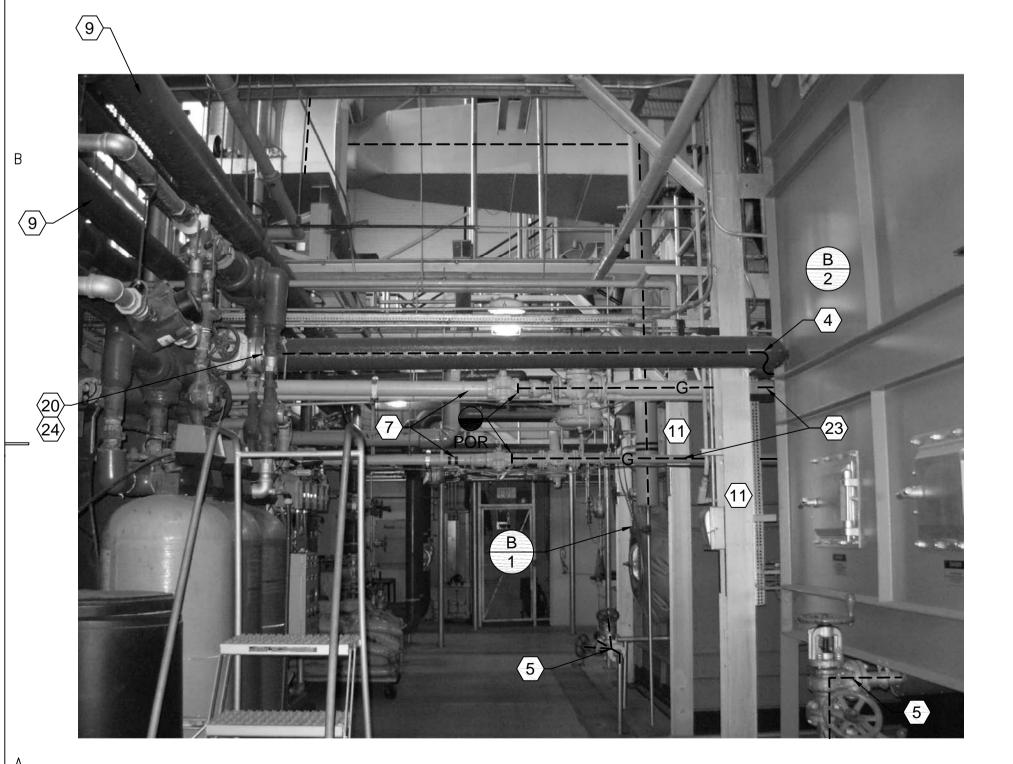


BOILER #1 PIPING LOOKING NORTH
SCALE: NONE

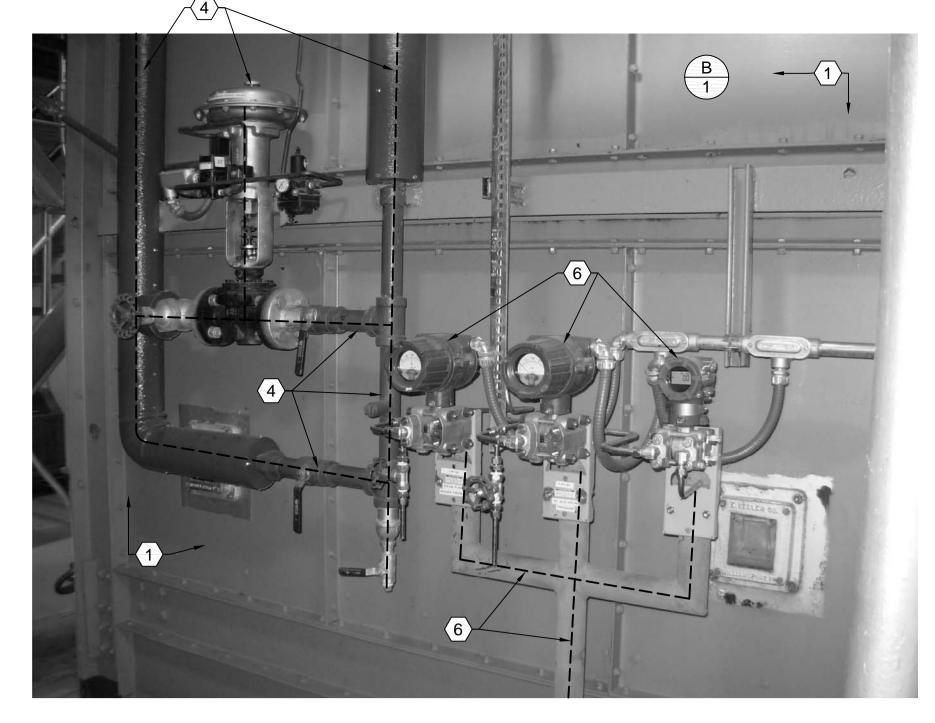


BOILER #1 FEEDWATER AND RECORDERS LOOKING SOUTHEAST

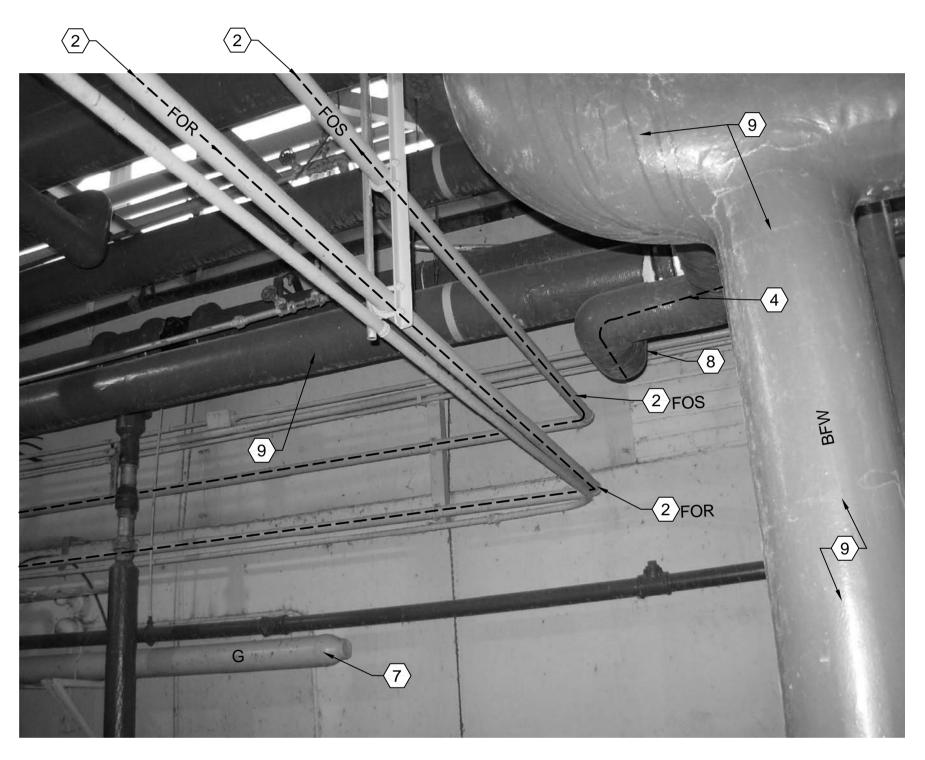

BOILER #1 FUEL OIL SUPPLY AND RETURN LOOKING WEST

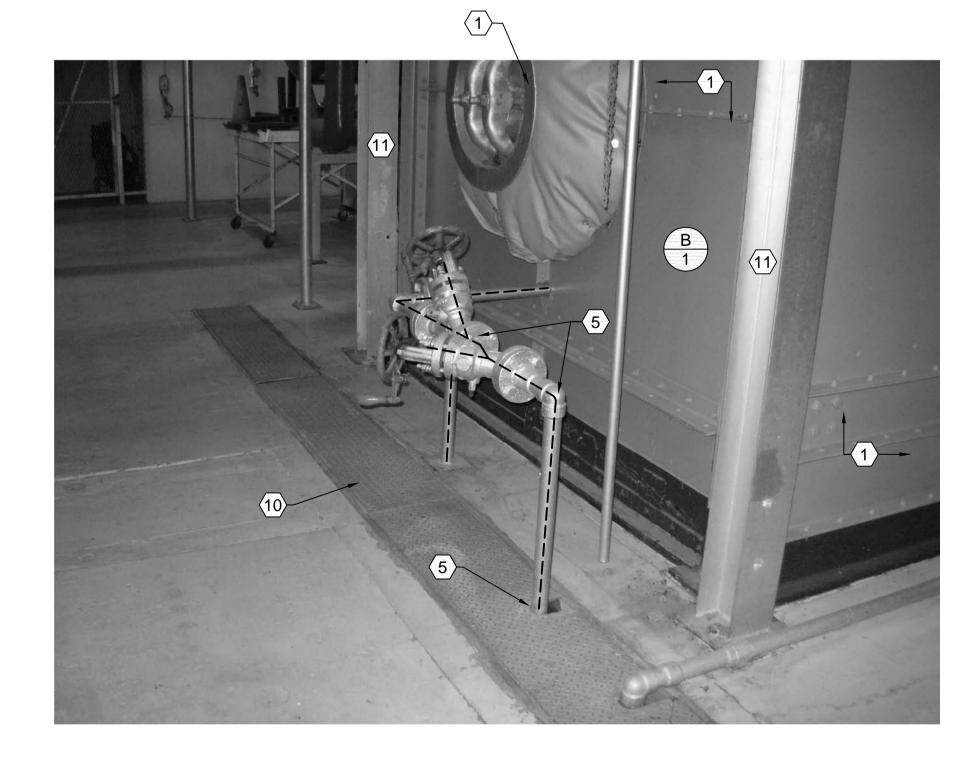


A3 BOILER #1 LOOKING NORTHEAST
SCALE: NONE

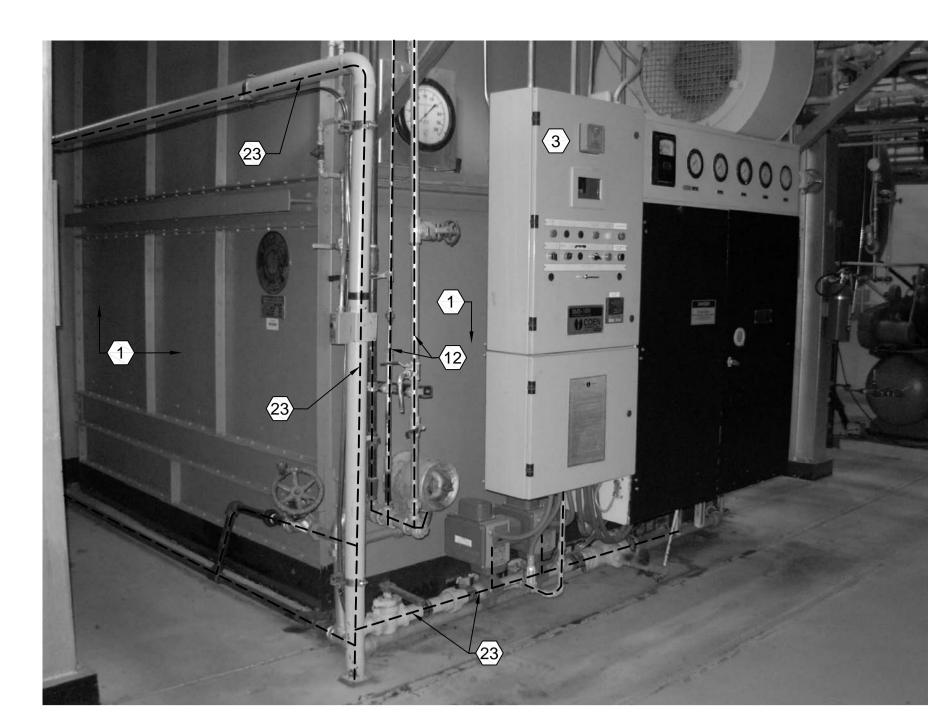

BOILER #1GAS AND BURNER LOOKING NORTHWEST



BOILER FEEDWATER AND OIL PIPING LOOKING NORTHWEST

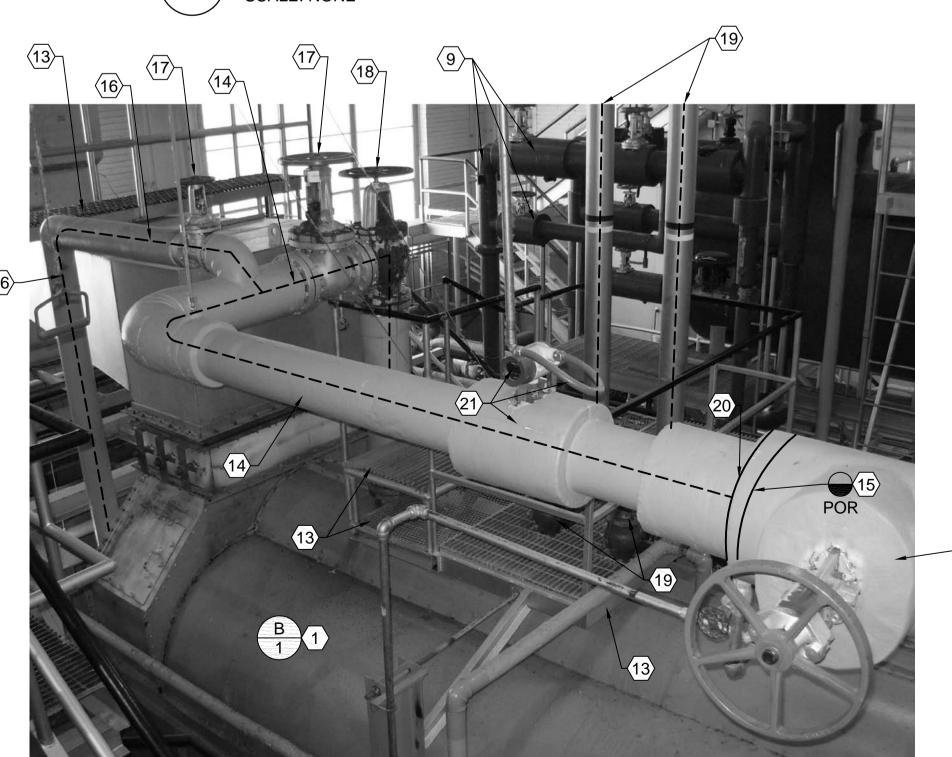

BOILER #1 STEAM PIPING LOOKING NORTHWEST
SCALE: NONE

- (1) REMOVE EXISTING BOILER #1 AND BOILER FOUNDATION.
- (2) REMOVE EXISTING OIL SUPPLY AND RETURN PIPING C/W BACK PRESSURE VALVE, STRAINERS, VALVES, SUPPORTS ETC.
- $\langle 3 \rangle$ REMOVE EXISTING BOILER BURNER, CONTROLS ETC.
- 4 REMOVE EXISTING BOILER FEED WATER PIPING INCLUDING PNEUMATIC CONTROL VALVE, VALVES, SUPPORTS, PNEUMATIC PIPING, ETC.
- (5) REMOVE EXISTING BLOWDOWN PIPING VALES ETC. CAP IN TRENCH UNDER COVER.
- 6 REMOVE EXISTING STEAM HEADER PRESSURE, FEED WATER PRESSURE AND BOILER DRUM PRESSURE RECORDERS INCLUDING SUPPORT.
- (7) EXISTING GAS PIPING SHALL REMAIN.
- REMOVE BOILER FEEDWATER TO THIS LOCATION AND CAP AT HEADER.
- (9) EXISTING BOILER FEEDWATER PIPING SHALL
- (10) UNDERFLOOR TRENCH AND COVER SHALL
- (11) COLUMNS SHALL BE REMOVED ONLY AFTER CATWALKS ARE NO LONGER REQUIRED FOR
- (12) REMOVE EXISTING DRAINS FROM BOILER #1
- (13) REMOVE EXISTING CATWALK ONLY AFTER THEY ARE NO LONGER REQUIRED FOR DEMOLITION.
- REMOVE EXISTING STEAM SUPPLY PIPING FROM BOILER #1.
- REMOVE STEAM PIPING TO VALVE INLET. PROVIDE BLIND FLANGE ON EXISTING VALVE.
- (16) REMOVE EXISTING STEAM SUPPLY TO SOOT
- (17) REMOVE EXISTING STEAM GATE VALVE.
- (18) REMOVE EXISTING STEAM ANGLE VALVE.
- REMOVE EXISTING RELIEF VALVES, PIPING, AND DRAIN ELLS. PATCH ROOF.
- 20 PROVIDE NEW BLIND FLANGE.
- 21 REMOVE EXISTING ORIFICE, FLANGES AND RECORDER, WIRING ETC.
- (22) EXISTING GATE VALVE SHALL REMAIN.
- REMOVE EXISTING GAS PIPING, GAS TRAIN, SUPPORTS, HANGERS, ETC. TO PLUG VALVE. PROVIDE CAP.
- REMOVE BFW TO VALVE. VALVE SHALL REMAIN. PROVIDE BLIND FLANGE ON EXISTING VALVE.

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CONSULTANTS



PROJECT NAME & ADDRESS


WEBER STATE UNIVERSITY HEATING **PLANT - BOILER REPLACEMENT**

DFCM No. 07049810


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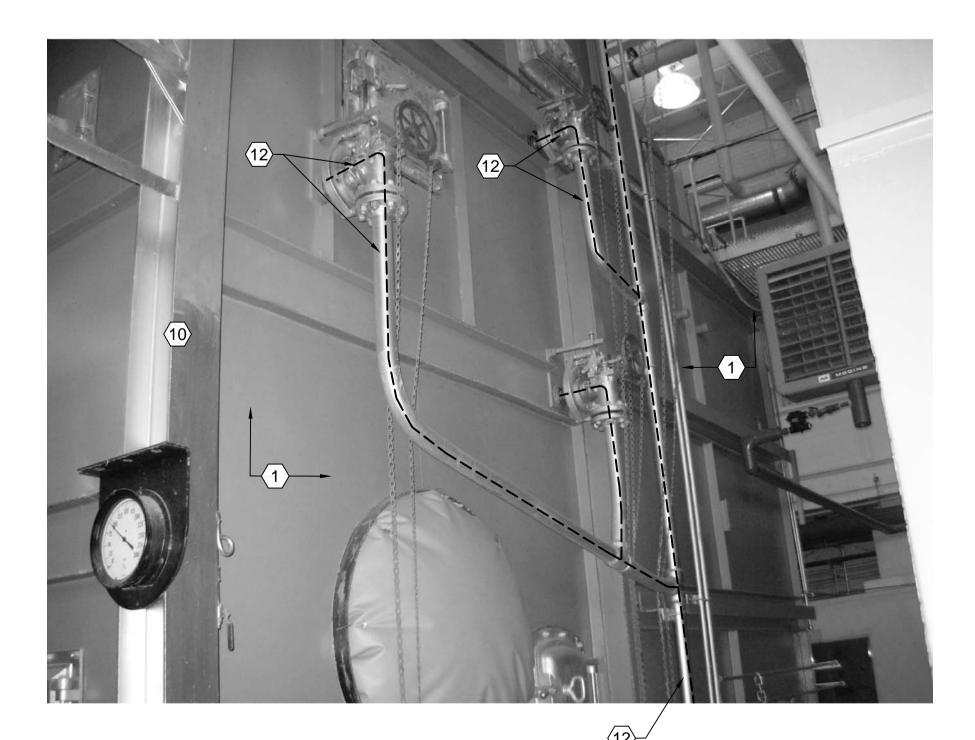
BOILER #1 DEMOLITION PHOTOGRAPHS




BOILER #2 LOOKING SOUTHEAST
SCALE: NONE

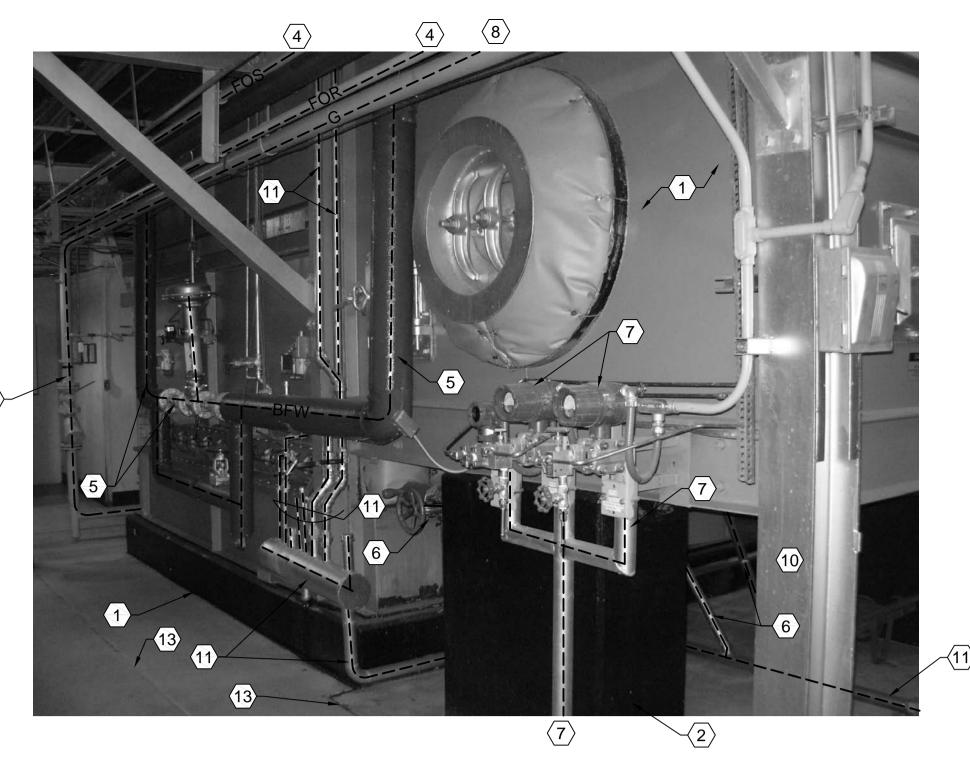


BOILER #2 LOOKING NORTH
SCALE: NONE

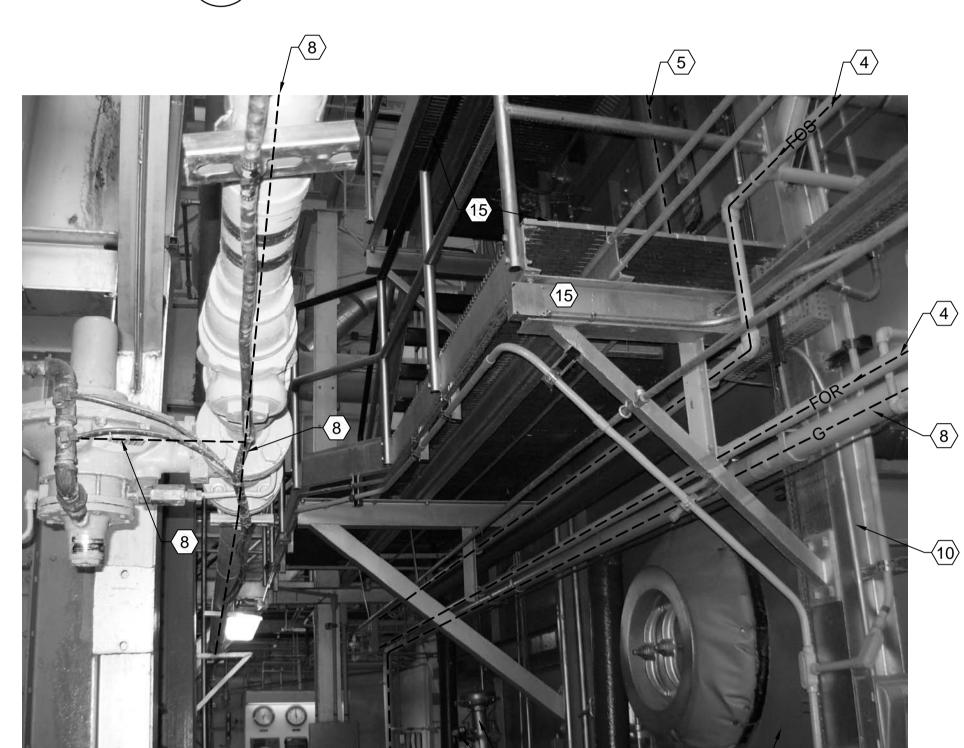


BOILER #2 LOOKING NORTHEAST
SCALE: NONE

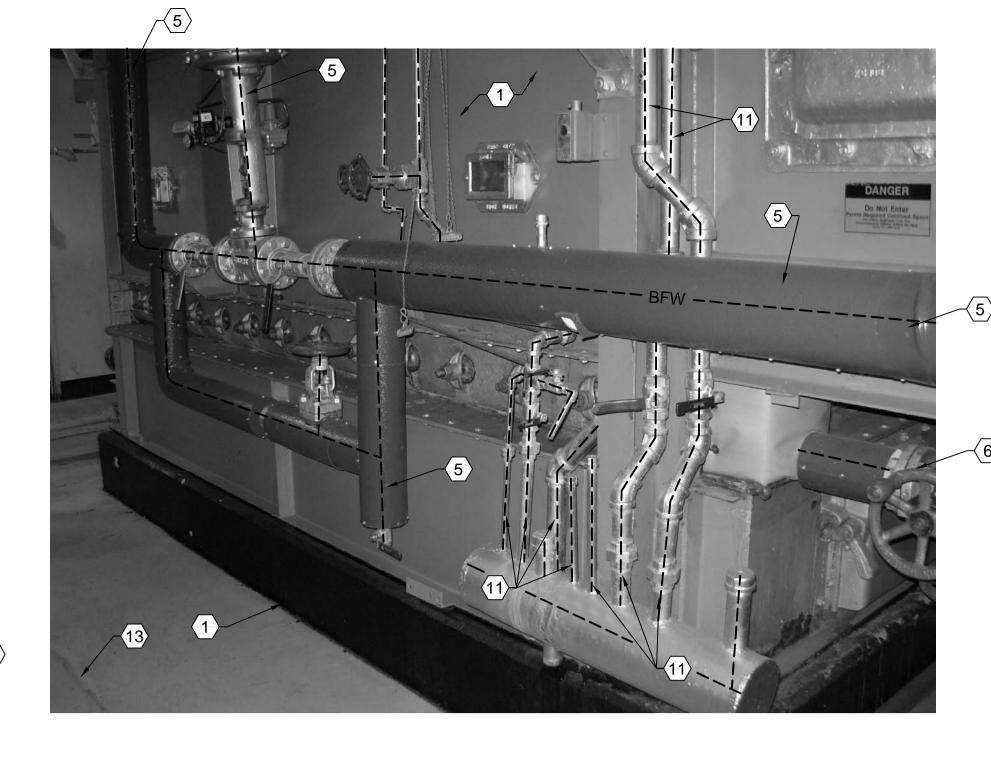


BOILER #2 LOOKING SOUTHEAST

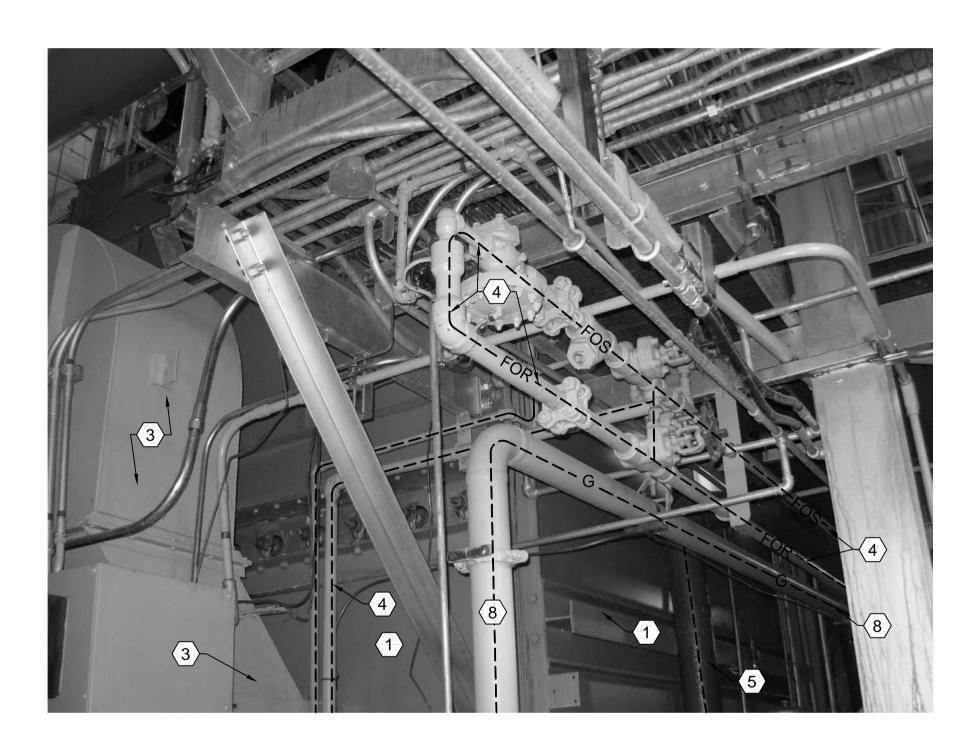


BOILER #2 LOOKING SOUTHWEST
SCALE: NONE

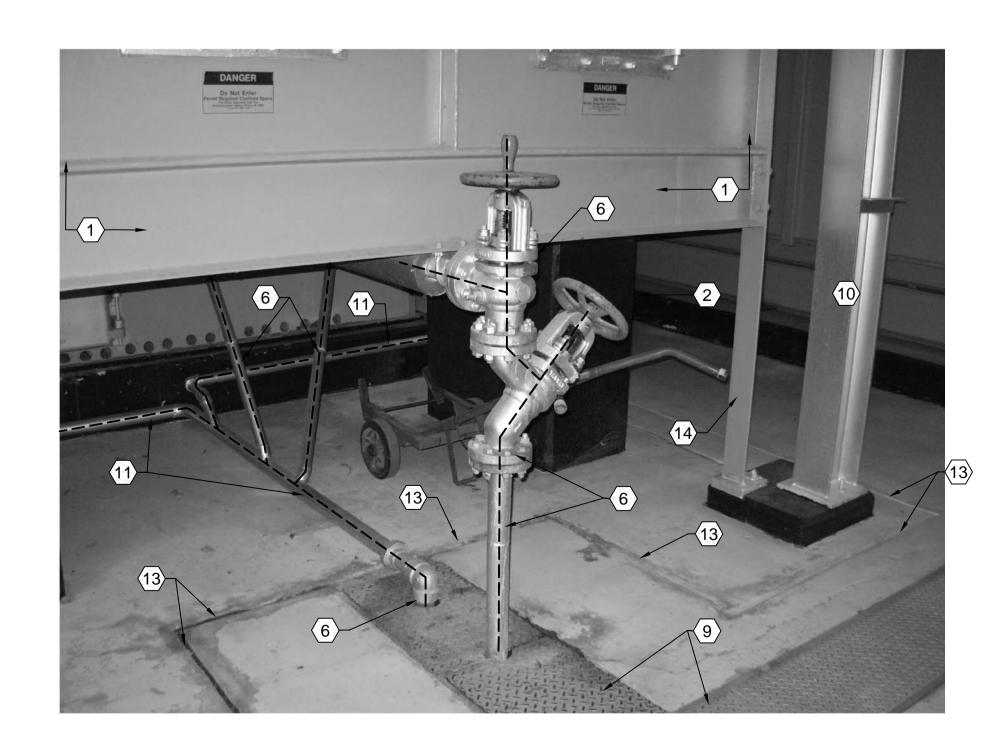


BOILER #2 BLOWDOWN A3 LOOKING SOUTHEAST SCALE: NONE

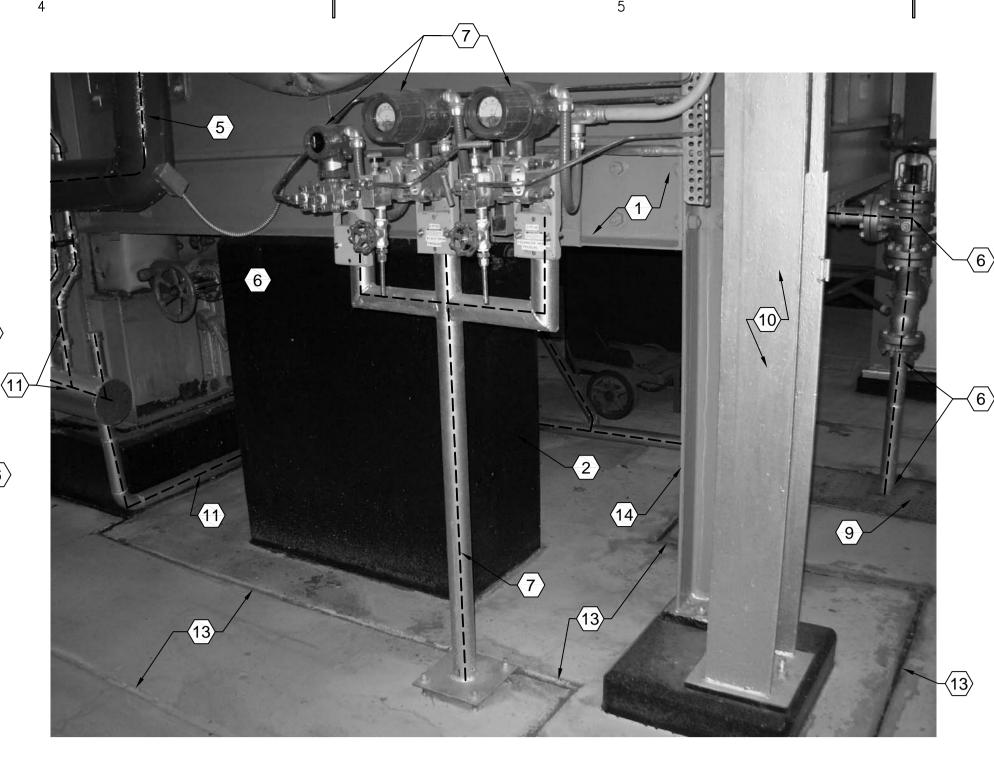

BOILER #2 LOOKING SOUTHEAST

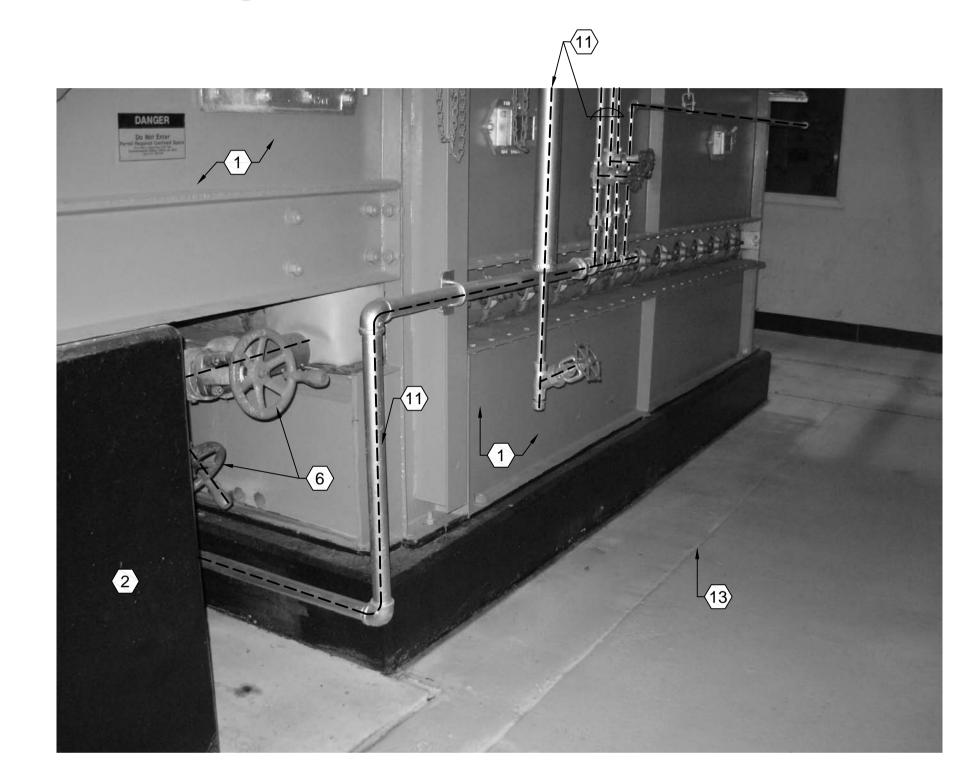

BOILER #2 DRAINS & BLOWDOWN LOOKING NORTHEAST
SCALE: NONE

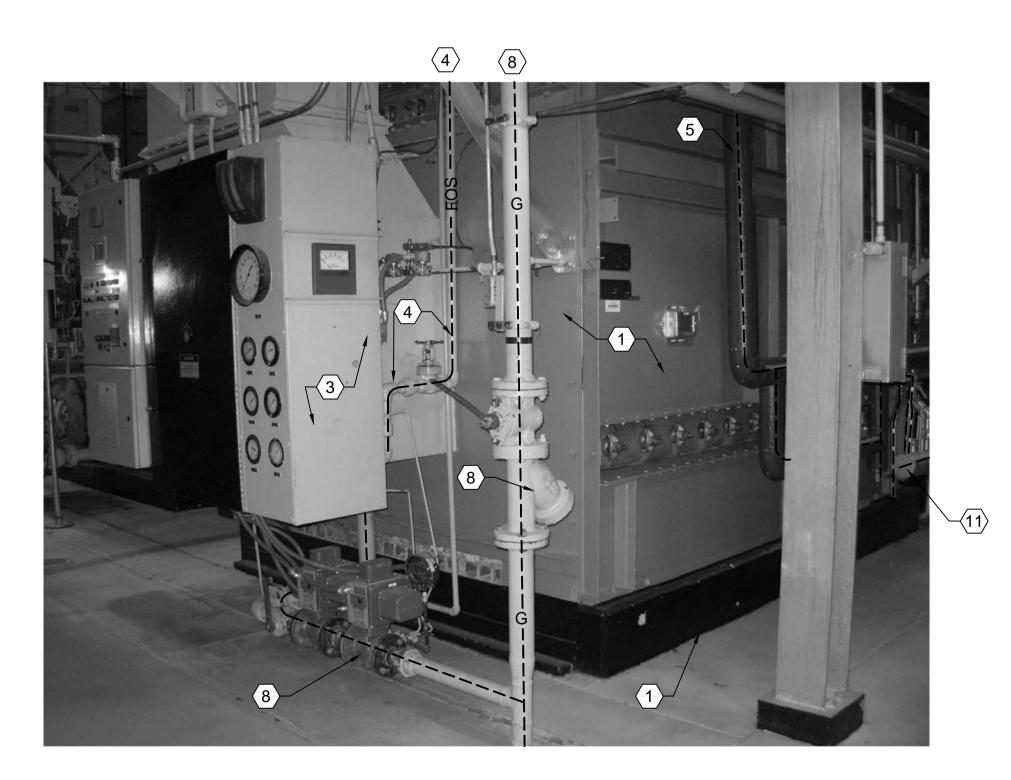

BOILER #2 GAS AND BURNER LOOKING SOUTHWEST

SCALE: NONE

- (1) REMOVE EXISTING BOILER #2 BURNER AND BOILER FOUNDATION.
- (2) REMOVE SUPPORT COLUMNS BOTH SIDES OF
- $\langle \overline{3} \rangle$ REMOVE EXISTING BOILER BURNER, CONTROLS ETC.
- REMOVE EXISTING OIL SUPPLY AND RETURN PIPING C/W BACK PRESSURE VALVE, STRAINERS, VALVES, SUPPORTS ETC.
- (5) REMOVE EXISTING BOILER FEEDWATER PIPING INCLUDING PNEUMATIC CONTROL VALVE, VALVES, SUPPORTS, HANGERS,
- PNEUMATIC PIPING, ETC. (6) REMOVE EXISTING BLOWDOWN PIPING, VALVES ETC. CAP IN TRENCH UNDER COVER.
- 7 REMOVE EXISTING BOILER #2 DRUM PRESSURE, STEAM HEADER PRESSURE AND FEEDWATER HEADER PRESSURE RECORDERS INCLUDING SUPPORT.
- $\overline{\langle 8 \rangle}$ REMOVE EXISTING GAS PIPING, GAS TRAIN, VALVES, SUPPORTS ETC.
- $\overline{\langle 9 \rangle}$ UNDER FLOOR TRENCH AND COVER SHALL
- (10) COLUMNS SHALL BE REMOVED ONLY AFTER CATWALKS ARE NO LONGER REQUIRED FOR DEMOLITION.
- (11) REMOVE EXISTING DRAINS FROM BOILER #2.
- REMOVE EXISTING SOOT BLOWERS AND ALL ASSOCIATED PIPING VALVES ETC.
- $\langle \overline{13} \rangle$ FOUNDATION CUT LINES.
- (14) REMOVE ANGLE SUPPORTS FOR BOILER.
- (15) REMOVE EXISTING CATWALK AND STRUCTURE ONLY AFTER IT IS NOT REQUIRED BY DEMOLITION CREWS.

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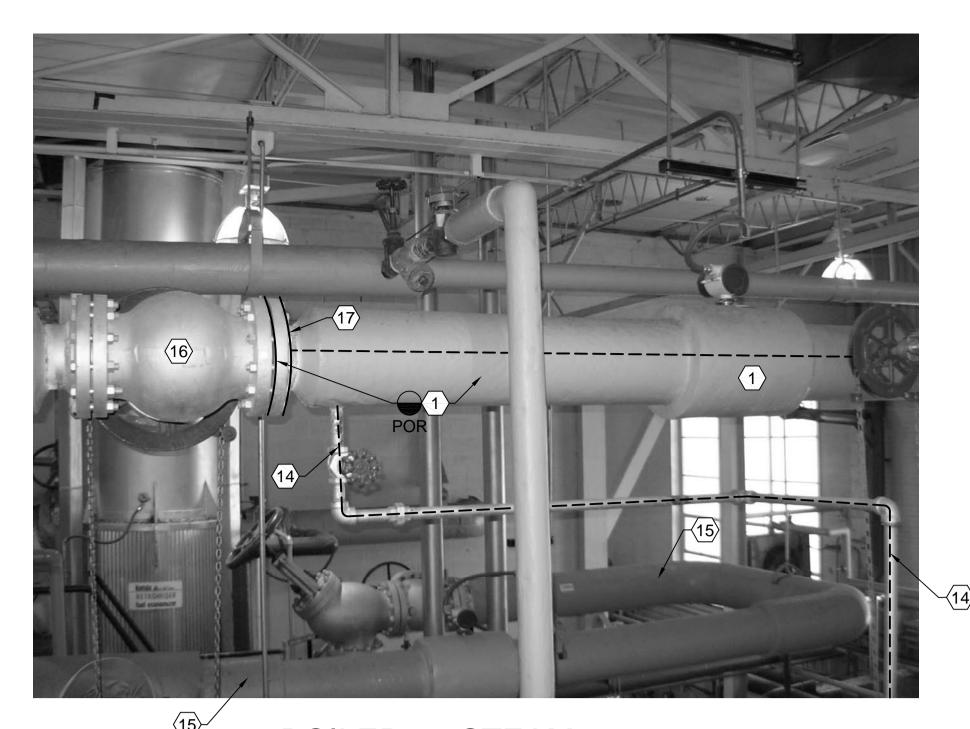
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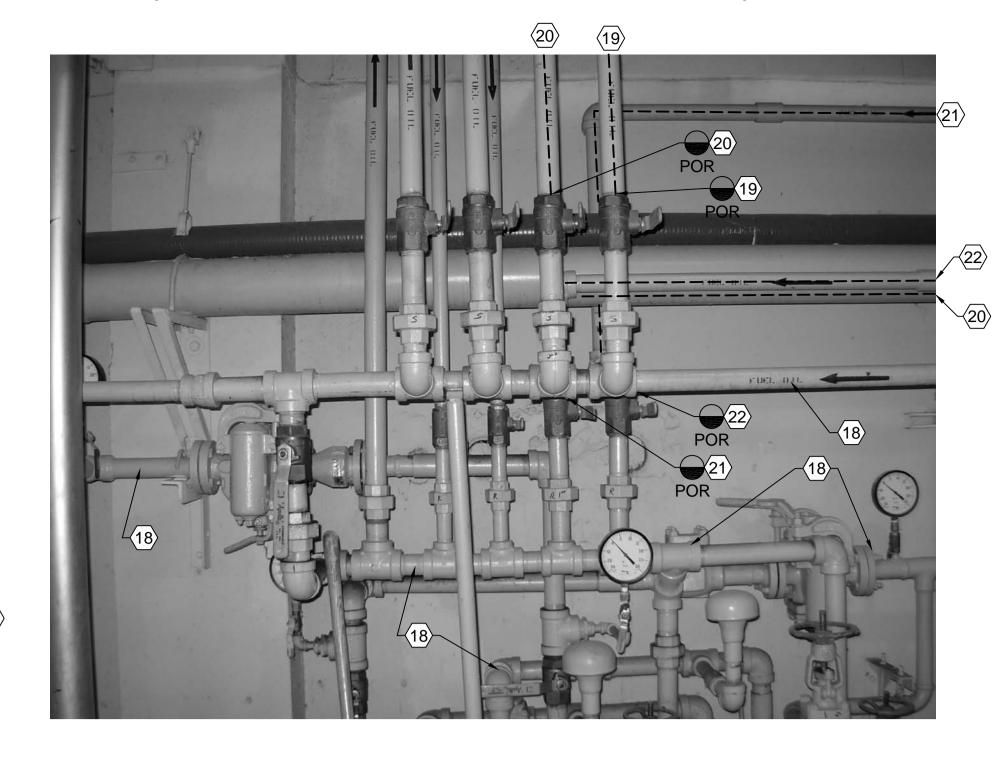
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11/9/07
WHW JOB NO.:
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SHEET TITLE


BOILER #2 DEMOLITION PHOTOGRAPHS



BOILER #2 STEAM
SUPPLY LOOKING SOUTHWEST
SCALE: NONE



OIL PIPING HEADER LOOKING WEST

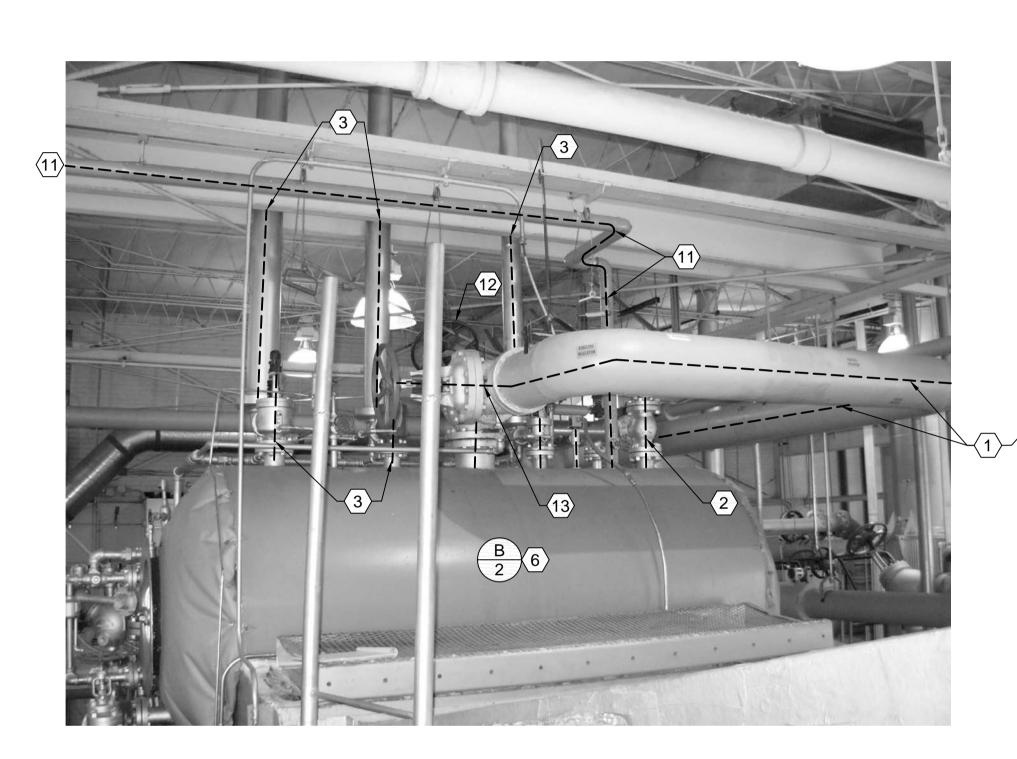


BOILER #2 LOOKING SOUTHEAST


SCALE: NONE



D4) BOILER ROOM LOOKING SOUTHWEST

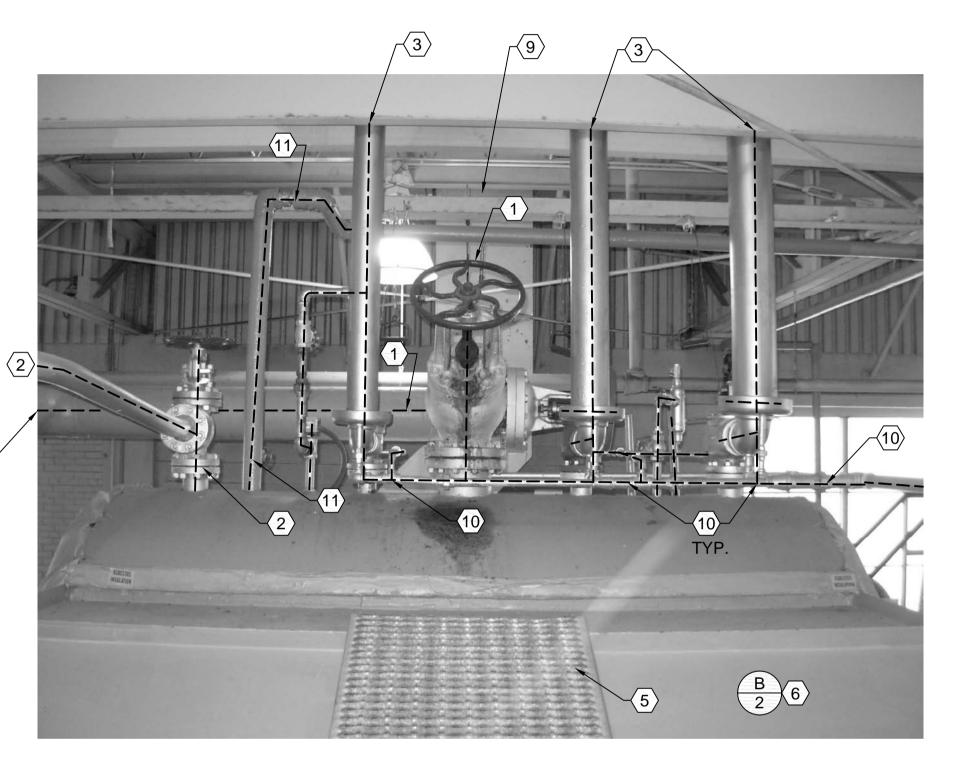

B4 TOP OF BOILER #2 LOOKING WEST

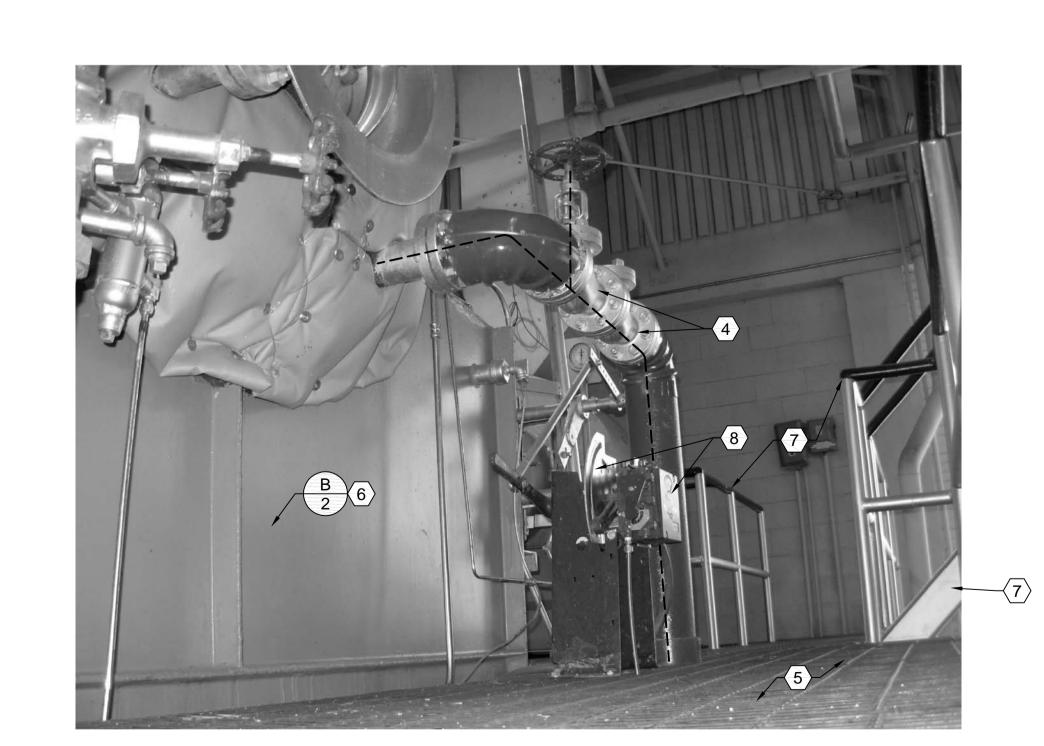

BOILER #2 BFW AND
CATWALK LOOKING SOUTHWEST
SCALE: NONE

- REMOVE EXISTING STEAM SUPPLY LINE INCLUDING ANGLE VALVE, GATE VALVE AND FLOW ORIFICE UP TO EXISTING GATE VALVE AT STEAM HEADER. PROVIDE BLIND FLANGE ON BOILER SIDE OF VALVE.
- 2 REMOVE EXISTING SOOT BLOWER STEAM SUPPLY PIPING VALVES ETC.
- (3) REMOVE EXISTING RELIEF VALVES, RELIEF PIPING THROUGH ROOF AND DRAIN ELL. PATCH ROOF.
- REMOVE UPPER LEVEL BOILER FEEDWATER PIPING, GATE VALES, CHECK VALVES, HANGERS ETC.
- 5 REMOVE EXISTING CATWALK ONLY AFTER DEMOLITION CREW NO LONGER REQUIRES CATWALK FOR ACCESS.
- 6 REMOVE EXISTING BOILER #2 AND ALL RELATED PIPING, STACKS, ELECTRICAL, CONTROLS, FOUNDATION ETC.
- 7 REMOVE EXISTING STAIRS AND RAILINGS
 ONLY AFTER DEMOLITION CREW NO LONGER
 REQUIRES THEM FOR ACCESS.

 8 REMOVE EXISTING DAMPER OPERATOR AND
- LINKAGE.

 (9) REMOVE BOILER STACK THRU ROOF. PATCH
- ROOF.
- 10 REMOVE ALL DRAIN AND VENT PIPING.
 11 REMOVE EXISTING STEAM PIPING VALVES
- (12) ANGLE VALVE.
- $\overline{\langle 13 \rangle}$ GATE VALVE.
- REMOVE EXISTING STEAM DRAIN LINE, VALVE, SUPPORTS, HANGERS ETC.
- (15) EXISTING STEAM SUPPLY FROM BOILER #3 SHALL REMAIN.
- (16) EXISTING GATE VALVE SHALL REMAIN.
- 17 PROVIDE BLIND FLANGE ON EXISTING VALVE.
- (18) EXISTING OIL PUMPS AND PIPING SHALL REMAIN EXCEPT FOR THAT SHOWN.
- REMOVE EXISTING FOS TO BOILER #1FROM VALVE TO BOILER. CAP VALVE.
- 20 REMOVE EXISTING FOS TO BOILER #2 FROM VALVE TO BOILER. CAP VALVE.
- 21 REMOVE EXISTING FOR FROM BOILER #1 TO VALVE. CAP VALVE.
- REMOVE EXISTING FOR FROM BOILER #2 TO VALVE. CAP VALVE.
- REMOVE EXISTING GAS LINE FROM BOILER TO VALVE ENTRANCE C/W ALL VALVES AND GAS TRAIN.
- 24 EXISTING GAS PIPING INCLUDING VALVE SHALL REMAIN.

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EMAIL: excellence@whw-engineering.com

PROJECT NAME & ADDRESS

WEBER STATE UNIVERSITY HEATING PLANT - BOILER REPLACEMENT

DFCM No. 07049810

Ogden, Utah

MARK	DATE	REVISION
PROJEC	Γ MANAGE	ER:
	SLW	

DRAWN BY:

LGD

CHECKED BY:

SLW/WP

DATE:

11/9/07

WHW JOB NO.:

07037


SHEET TITLE

11/09/07 WINWARD M. PACKER No. 375080


BOILER 1# & #2 DEMOLITION PHOTOGRAPHS



ROOF LOOKING SOUTH

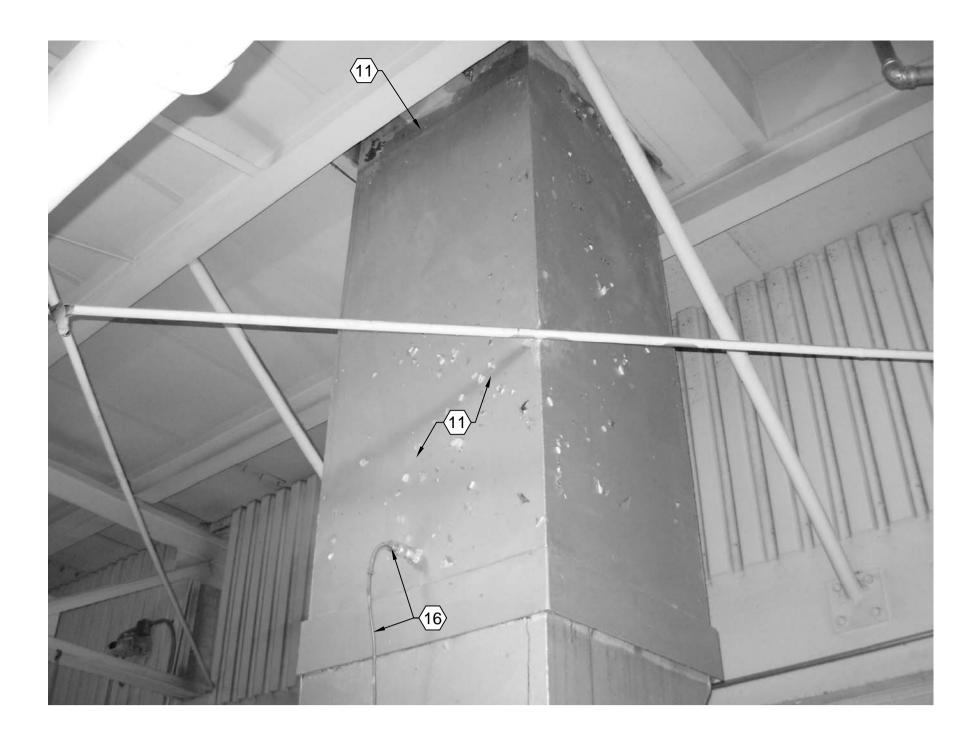

BOILER #2 STACK THRU-ROOF LOOKING SOUTHWEST

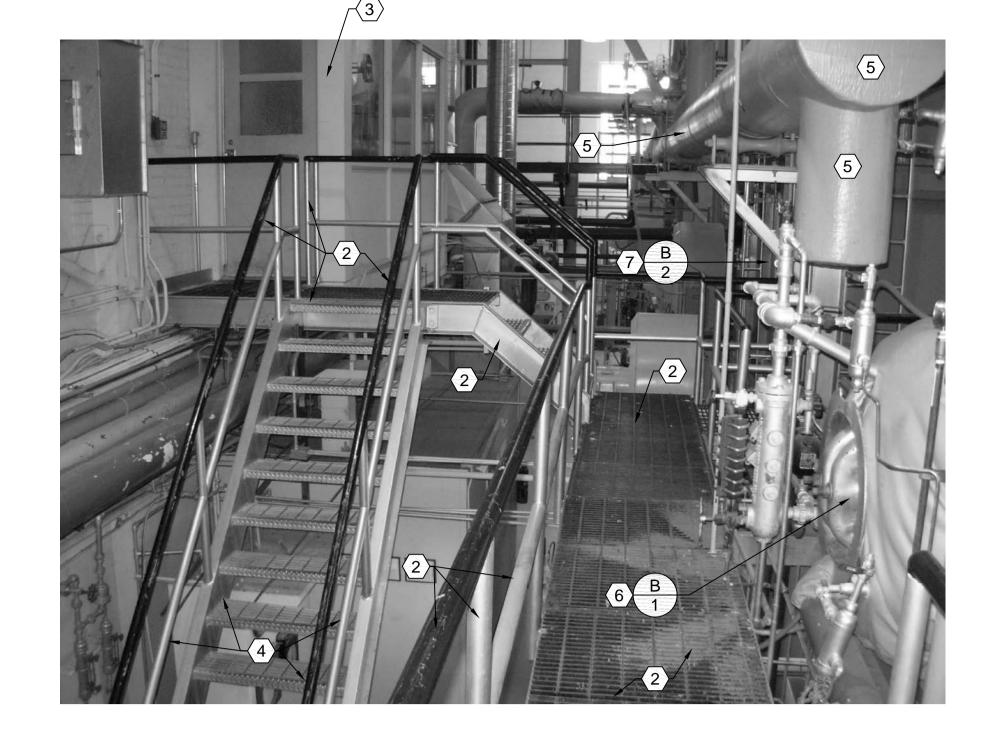


EASTSIDE CATWALK AND STAIRS LOOKING SOUTH




BOILER #1 STACK THRU ROOF LOOKING NORTHWEST
SCALE: NONE




BOILER #2 FAN, STACK, CATWALK AND STRUCTURAL LOOKING SOUTHWEST
SCALE: NONE

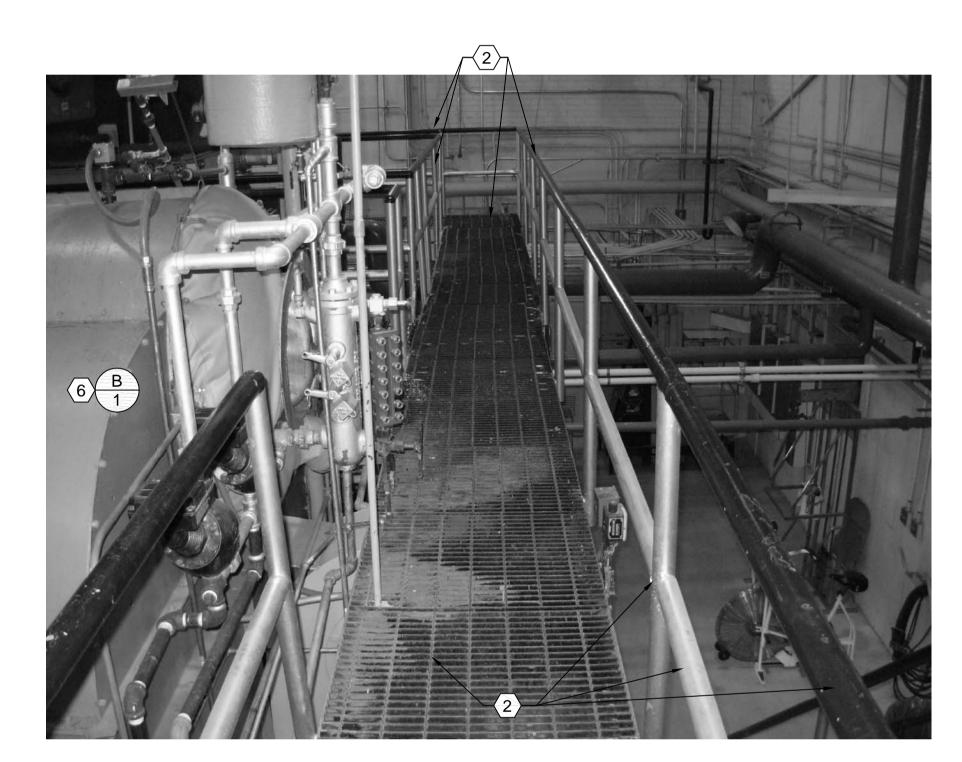


EASTSIDE CATWALK LOOKING NORTH SCALE: NONE

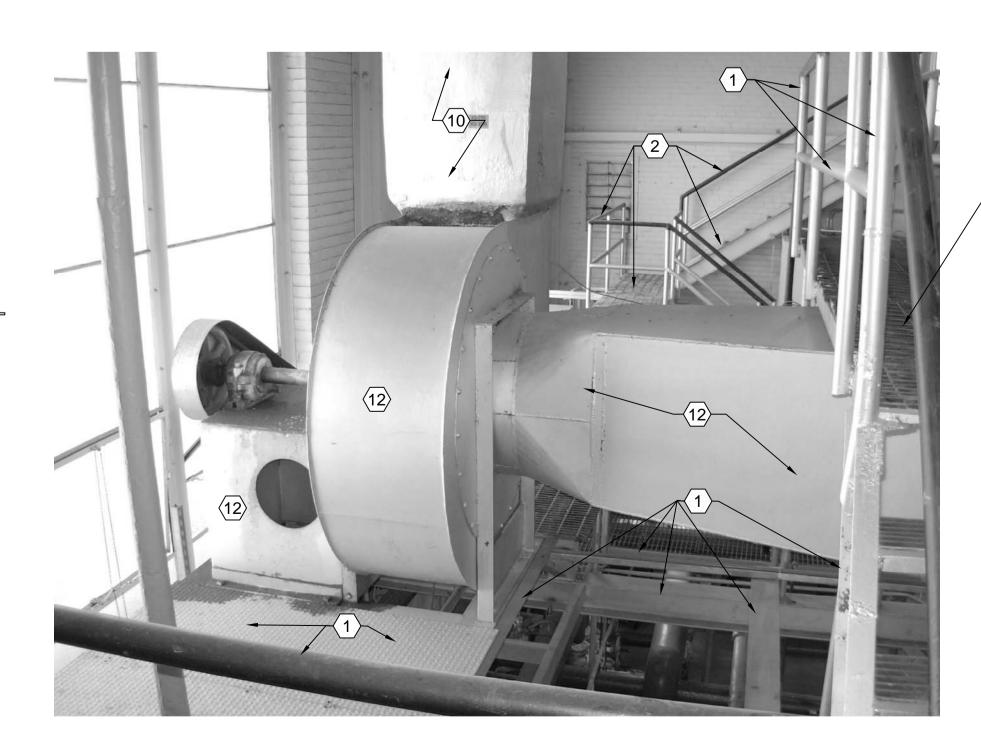

BOILER #1 FAN, STACK, CATWALK AND STRUCTURAL LOOKING NORTH
SCALE: NONE

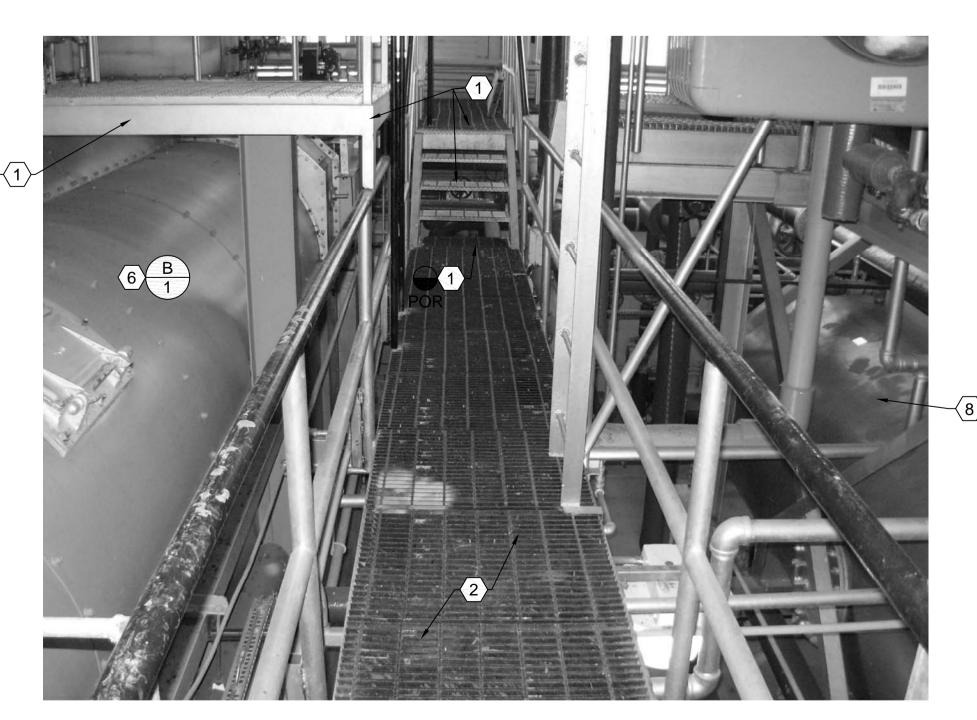

CATWALK BETWEEN BOILER #1 AND DEAERATOR LOOKING WEST (A3) AIND DEASCALE: NONE

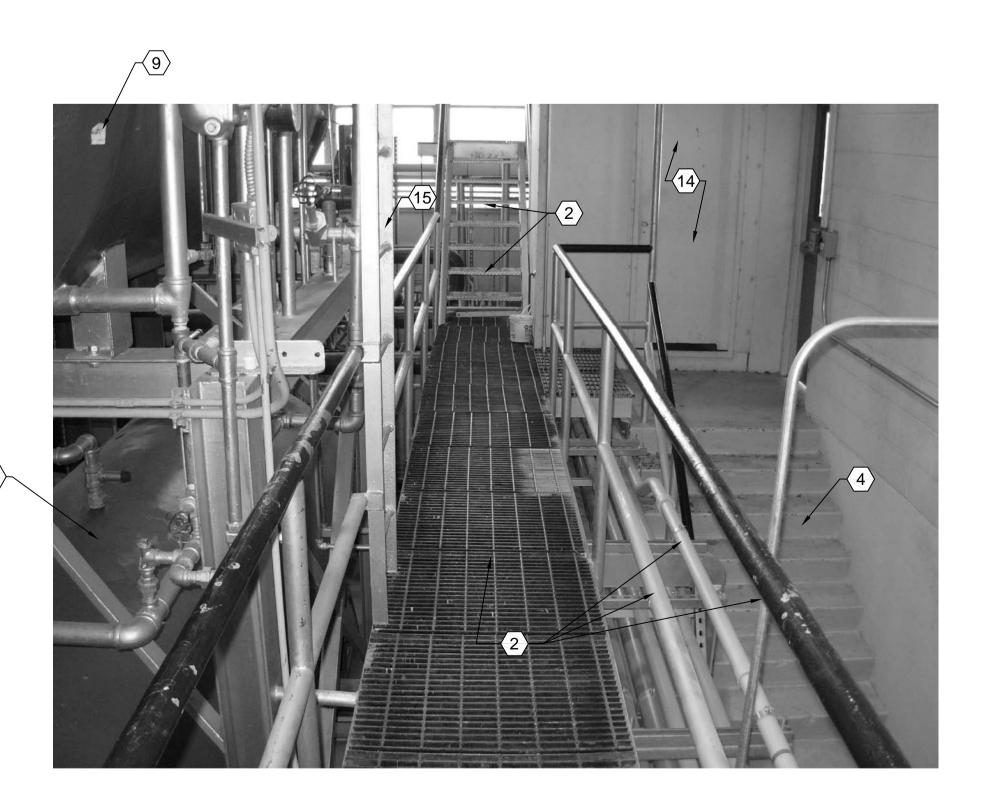

NORTHEND CATWALK LOOKING WEST SCALE: NONE

- 1 REMOVE EXISTING CATWALKS, HANDRAILS, STAIRS, ETC. WHEN NO LONGER REQUIRED BY DEMOLITION CREWS.
- $\langle 2 \rangle$ EXISTING CATWALKS, HANDRAILS, STAIRS, ETC. SHALL REMAIN.
- $\langle 3 \rangle$ EXISTING CONTROL ROOM.
- 4 EXISTING STAIRS TO BOILER ROOM FLOOR SHALL REMAIN.
- $\langle 5 \rangle$ EXISTING STEAM HEADER, DRIP LEGS, AND TRAPS SHALL REMAIN.
- 6 REMOVE EXISTING BOILER #1 AND BURNER AND ALL ASSOCIATED CONTROLS, PIPING, VALVES, STRUCTURAL, ETC.
- 7 REMOVE EXISTING BOILER #2 AND BURNER AND ALL ASSOCIATED PARTS, PIPING, CONTROLS, VALVES, STRUCTURAL, ETC.
- (8) EXISTING CONDENSATE RECEIVER TANK AND ALL PIPING, VALVES, ETC. FOR SYSTEM #1 SHALL REMAIN.
- $\overline{\left\langle 9\right\rangle }$ EXISTING DEAERATOR AND ALL PIPING, VALVES, ETC. FOR SYSTEM #1 SHALL REMAIN.
- (10) REMOVE EXISTING INTERIOR STACK FROM
- BOILER #1 AND PATCH ROOF OPENING. (11) REMOVE EXISTING INTERIOR STACK FROM BOILER #2 AND PATCH ROOF OPENING.
- (12) REMOVE BOILER #1 FAN, STACK, MOTOR, ELECTRICAL, ETC.
- (13) REMOVE BOILER #2 FAN, STACK, MOTOR, ELECTRICAL, ETC.
- (14) EXISTING RESTROOM SHALL REMAIN.
- REMOVE SHIPS LADDER WHEN NO LONGER REQUIRED BY DEMOLITION CREW.
- (16) REMOVE EXISTING STACK SENSOR AND THERMOMETER.
- $\langle \overline{17} \rangle$ REMOVE FLUE STACKS ABOVE ROOF.
- (18) EXISTING STACKS FOR BOILERS #3 AND #4 SHALL REMAIN.
- (19) FRESH-AIR PENTHOUSE SHALL REMAIN.
- (20) ACCESS LADDER TO ROOF.
- (21) REMOVE EXISTING RELIEF PIPING FROM BOILER RELIEF VALVES AND PATCH ROOF.

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11/9/07 WHW JOB NO.: 07037 SHEET TITLE

ROOF & CATWALK DEMOLITION

PHOTOGRAPHS